03 - HIGHWAY DESIGN INDEX OF DRAWINGS


DRAWING NUMBER	DRAWING TITLE	DRAWING NUMBER	DRAWING TITLE	
HWY-01	INDEX OF DRAWINGS			
BOR-01 - BOR-03	BORING REPORTS			
MDS-01 - MDS-03	MISCELLANEOUS DETAIL SHEETS			
TYP-01 - TYP-02	TYPICAL SECTIONS			
GRD-01 - GRD-02	INTERSECTION GRADING PLAN			
PLN-01 - PLN-02	PLAN SHEETS			
PRO-01 - PRO-03	PROFILE SHEETS			
(SC-01 TO XSC-20	CROSS SECTIONS			
STG-01 - STG-02	STAGE CONSTRUCTION PLANS			

THE DESIGN APPEARS TO CONFORM TO APPLICABLE CRITERIA. APPROVAL IS NOT TO BE CONSTRUED TO MEAN THAT ALL ASPECTS OF THE DESIGN HAVE BEEN PERSONALLY CHECKED BY THE UNDERSIGNED. TRANSPORTATION PRINCIPAL ENGINEER

					DESIG
-	-	-	-	THE INFORMATION, INCLUDING ESTIMATED	
-	-	-	-	QUANTITIES OF WORK, SHOWN ON THESE SHEETS IS BASED ON LIMITED	CHEC
-	-	-	-	INVESTIGATIONS BY THE STATE AND IS IN NO WAY WARRANTED TO INDICATE	
_	-	-	-	THE CONDITIONS OF ACTUAL QUANTITIES	
-	-	-	-	OF WORK WHICH WILL BE REQUIRED.	
-	-	-	-		
RFV.	DATE	REVISION DESCRIPTION	SHEET NO.	Plotted Date: 11/18/2014	I

DESIGNER/DRAFTER:	
JS	
CHECKED BY:	
PM	

STATE OF CONNECTICUT **DEPARTMENT OF TRANSPORTATION** Filename: ...\HW_MST_0043_0128_Index.dgn

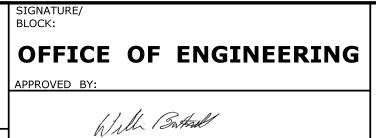

REHABILITATION OF BRIDGE NO. 01665 AND INTERSECTION REALIGNMENT OF ROUTE 100 AT U.S. ROUTE 1

OWN:	FAST	HAVEN
	LASI	ПАУСИ

43-128 DRAWING NO.
HWY-01 SHEET NO. **03.01** HIGHWAY COVER SHEET

Driller:	•	T. Mallory	C	onn	ecticu	t DOT Boring Repo	rt Hole No.: B-1
Inspec		G. Arzt	Tov			AST HAVEN	Stat./Offset:13+19/15ft LT
Engine	eer:	Brett McKiernar	Pro	ject I	No.:00	43-0128	Northing: 661700.522
Start D	<u> Date:</u>	12/2/2010	Rou	<u>ıte N</u>	<u>o.: 10</u>	0	Easting: 968830.520
Finish	Date	:12/2/2010	Bric	lge N	lo.: 01	665	Surface Elevation: 19.27
Projec	t Des	scription:Bridge F	Rehak	oilitat	ion		
Casing	g Siz	e/Type:4in HW	Sar	npler	. Type	/Size:SS 1 3/8in	Core Barrel Type:NQ2
Hamm	er W	/t.: Fall:	Har	nme	r Wt.:1	40lbs Fall: 30in	
Ground	dwat	er Observations	<u>@</u> 23.	2afte	r 0	hours, @ after	hours, @ after hours
		SAMPLES				on	(ff.)
Depth (ft)	<u>o</u> <u>o</u>	Blows on	į	<u> </u>	(E) %	Generalized Strata Description	Material Description 등
닭 [닭	sample Type/No.	Sampler				Genera Strata Descri	Material Description
	yp 'yp	per 6 inches		ס	RQD	Stra	
	_	per o mones	<u>, </u>	<u> </u>			
0 -						PAVEMENT 6	" Asphalt
						STRUCTURE /	" Asphalt
\dashv						MISCELLANEOUS	-
5						FILL	15
	S-1	5 4 6 4	24	1 1	0	I I	ed Brown C-F SAND, some c-f Gravel, tle Silt
4						"	
10 🎞							<u> </u>
`° ∦s	S-2	5 3 3 3	24	1 3		B	rown C-F GRAVEL, some c-f Sand, tr Silt
15						SANDY GRAVEL	⊢ 5
'3][s	S-3	30 50	11	1 6			ed C-F SAND and C-F GRAVEL, little Silt
							<u> </u>
							F ₀
20 s	6-4 /	50	1	1		F	ed C-F SAND and C-F GRAVEL, little Silt
1							-
\exists							- 5
25 <u> </u> C	 C-1					BEDROCK F	ed SANDSTONE medium grained medium
\exists			60) 3	4 28	, b	edded moderately fractured moderately
1					. _`	[W	eathered and very strong
30 -	D-2						ed SANDSTONE medium grained medium
] `	<i>J</i> -2		60) 5	6 40	. b	edded moderately fractured slightly
			00	, ,	0 4	' W	eathered and very strong
35 ⅃ႃ—						\ P	ttom of Boring
							ottom of Boring
	Saı	mple Type: S=S	Split S	poor	n C=C	ore UP = Undisturbe	ed Piston V = Vane Shear Test
F	Prop	ortions Used: Ti	race =	= 1 -	10%,	Little = 10 - 20%, S	Some = 20 - 35%, And = 35 - 50%
Total F	Pene	tration in		TON	ES:L	ost water at 6.5ft. De	nse layer 16ft to 18ft. Sheet
		Rock: 10					ater return during core. 1 of 1
				Wat	er con	ning out of south abut	
INO. OT	Sam	ples: 6					SM-001-M REV. 1/02

Drille	er:	T. N	/lallo	ory		C	onne	cticut	DOT Boring Re	port	Hole No.: B-2		
	ector:	G. /				Tow			ST HAVEN		Stat./Offset:14+		
	neer:				ernan		Project No.:0043-0128 Northing: 661674.185 Route No.: 100 Easting: 968937.425						
	Date:										<u> </u>	3937.425	
	h Date				das D	•		.: 016	65		Surface Elevati	on: 15.42	
	ect Des								2::00 1 2/0:-		Cara Darral Tur		
	<u>ng Size</u> mer W			<u>ın r</u> all:	100		-	<u>уре/s</u> Vt.:14	<u>Size:SS 1 3/8in</u> 0lbs Fall: 30in		Core Barrel Typ	be.NQZ	
	ındwat				ions (hours, @ aft	er hou	rs, @ after	hours	
					LES	<u></u>					3, 65		(ft)
(L	le lo.		Blo	ows	on	(in.)	(in.)	%	Generalized Strata Description		Material Descr	ription	
Depth (ft)	Sample Fype/No.		Sa	amp	ler			QD o	ata scri		and Notes	3	/ati
De	Sample Type/No.		per	6 ir	ches	Pen.	Rec.	RG	Ger Stra De				Elevation
_	•												-
⁰╗									MISCELLANEOUS				<u> </u>
1									FILL				_
5 -													
Ĭ 🖠	S-1	16	28	15	8	24	12			Red Brow Gravel w/	/n C-F SAND, little : /cobble	Silt, little c-f	─ 10 -
\exists										Clavel W	CODDIC		_
10										D 0	E OAND (1	0 1 1111 011	- 5
1	S-2	4	5	3	3	24	4			Brown C-	F SAND, some c-f	Gravel, little Silt	
													F
15 -	S-3	_	•	0	7		10			Ton: Red	C-F Gravel, some	c-f sand little	- - 0
4	<u> </u>	5	6	8	1	24	10			Silṫ		·	_
1										Bottom: F little f-c S	Red Brown SILT, litt and	le c-f Gravel,	-
20	S-4	8	15	11	20	24	12		WEATHERED BEDROCK	Tan C-F (GRAVEL and C-F S	SAND. tr Silt	_ -5
\dashv			10	• •	20		'-					,	-
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25 – -	S-5	5	19	11	12	24	12			Gray BAS	SALT completely we	eathered	10
													-
30 -													-
~ H	C-1								BEDROCK		DSTONE medium of the contract		<u> </u> -15 -
4						60	57	60			d and strong	siigiitiy	_
35													- 20
	C-2										DSTONE medium of the strain of		20 -
						60	60	60		and stron		,	-
40]										Bottom of B	orina	/	H
										DOMOIT OF D	omig		
	Sar	nnle	Tv	Je.	S=S	l nlit Sr		<u> </u> 	<u>l</u> ore UP = Undistu	l rhed Dist	n V = Vane Sh	ear Test	
		-				-			Little = 10 - 20%,				
Tota					4. 116				n cobble at 2.5 ft.			1	
	l Penet h: 30								wash 10'-14', 27'-		yer nom zon	Sheet 1 of 1	
				10					water return 30'-		40'		
110. (of Sam	pies	. /									SM-001-M REV. 1	/02

					DE
				THE INFORMATION, INCLUDING ESTIMATED QUANTITIES OF WORK, SHOWN ON THESE SHEETS IS BASED ON LIMITED INVESTIGATIONS BY THE STATE AND IS IN NO WAY WARRANTED TO INDICATE	CH
				THE CONDITIONS OF ACTUAL QUANTITIES OF WORK WHICH WILL BE REQUIRED.	
REV.	DATE	REVISION DESCRIPTION	SHEET NO.	Plotted Date: 11/18/2014	

DEP

STATE OF CONNECTICUT PARTMENT OF TRANSPORTATION

Filename: ...\HW_MST_0043_0128_Boring.dgn

Will Butal

OFFICE OF ENGINEERING REHABILITATION OF BRIDGE NO. 01665 AND INTERSECTION REALIGNMENT OF ROUTE 100 AT U.S. ROUTE 1

EAST HAVEN

BORING REPORT

PROJECT NO. **43-128** DRAWING NO.
BOR-01 SHEET NO. 03.02

Driller:	T. Mallory	Co	nnec		DOT Boring Re	port	Hole No.: B-3		
Inspector:	G. Arzt	Town	1:	Stat./Offset:13+ Northing: 661	34/13ft RT				
Engineer: Brett McKiernan F			ct No	674.915					
	: 12/7/2010		<u>e No.:</u>					849.718	
	e:12/7/2010		e No.		65		Surface Elevation	on: 18.34	
<u>Project De</u>	scription:Bridge R	<u>Rehabil</u>	itatior	1			<u> </u>		
Casing Siz	ze/Type:4in HW	Sam	oler T	ype/S	Size:SS 1 3/8in		Core Barrel Typ	e:NQ2	
<u> Hammer V</u>	<u>Vt.: Fall:</u>	Hami	mer W	/t.:14	<u> 0lbs Fall: 30in</u>				
<u>Groundwa</u>	ter Observations (<u>@13.3</u>	after C)		<u>ter hou</u>	<u>rs, @ after</u>	hours	
	SAMPLES	$\neg \neg$	Τ	I	Generalized Strata Description				(ff.)
	Blows on	(in.)	(in.)	%	rali;		Material Descr	iption	ion
Depth (ft) Sample Tvpe/No.	Sampler	en. (QD	Generalized Strata Description		and Notes		Elevation
Sa De	per 6 inches	Pe	Rec.	R	Ge Str De				E e
⁰╗					PAVEMENT	3" Asphal	t 4" Concrete		
1					STRUCTURE	/			F
7					MISCELLANEOU FILL	S			- 15
5 - S-1	3 3 3 3	24	2		' '	Red Brow	n C-F GRAVEL, so	me c-f Sand, tr	╠
-	-	-	-			Silt, w/brid	ck fragments	·	F
1					SANDY	1			- 10
10 S-2	47 48 50	17	12		GRAVEL	Red C-F	SAND and C-F GRA	AVEL. tr Silt	⊩
1 -	1		-						
1									- 5
15 - S-3	20 27 27 47	24	15			Red C-E	SAND, little Silt, tr f-	.c Gravel	F
	28 27 37 47	24	13			Tred o 1	or and, mad one, a r	o Glavei	
									- o
20 - S-4	50	2	2			Pod C.E.	GRAVEL, some c-f	Sand little Silt	F
1/0-4	/					I Neu C-I	GIVAVEL, SOME C-1	Sand, iitile Siit	
									 - -5
25 -									
C-1	-				BEDROCK	H BON SAN	DSTONE medium g	rained medium	Ľ
		60	60	88	BEDITOOK	bedded m	noderately fractured	slightly	-1
30 -		60	60	00		weathere	d and extremely stro	ong	
- C-2	-					Pod CAN	DSTONE	trained medicus	ŀ
- 0-2			E0	00		bedded m	DSTONE medium g noderately fractured	slightly	-1
35 -		60	58	63			d and extremely stro		
	-					Dotton: cf D	oring	,	L
						\Bottom of B	oning	/	
Sa	mple Type: S=S	plit Sp	oon (C=Cc	ore UP = Undistu	ırbed Pisto	on V = Vane She	ear Test	
Prop	ortions Used: Tr	ace =	1 - 10	%, I	Little = 10 - 20%,	Some =	20 - 35%, And	d = 35 - 50%	
Total Pene	etration in	IN	IOTES	S: Soi	il becomes dense	e at 14ft, c	asing advanced	Sheet	
	5 Rock: 10				Roller bit moved	,	•	1 of 1	
No. of San		C	ompe	tent r	ock possible at 2	23.5ft			
ivo. Oi Sali	ilpies. U							SM-001-M REV. 1	/02

Drille			1allo	ry		C	onne		DOT Boring Re	port	Hole No.: B-4		
	ector:	G. <i>F</i>		,		Tow			ST HAVEN		Stat./Offset:14-		
	neer:				ernan		Project No.:0043-0128 Northing: 661708.						
	<u>t Date:</u>						Route No.: 100 Easting: 968911.702 Bridge No.: 01665 Surface Elevation: 15.22						
	sh Date						•		65		Surface Elevati	on: 15.22	
	ect Des										<u> </u>		
	ng Size				IVV				Size:SS 1 3/8in		Core Barrel Typ	oe:	
	mer W		Fa		iono /	_		<u>//t.:14</u>		tor bou	ro @ offer	houre	
Giol	<u>ındwat</u> İ	ei Oi			LES	<u>w</u> 13.5	aner	<u> </u>		ter hou I	rs, @ after	hours	(#)
ft)	η <u>ς</u>		Blo			T 🔁	<u> </u>		Generalized Strata Description		Material Desci	rintion	1
Depth (ft)	Sample Type/No.		Sa	mn	ler	(in.)	(in.)	% (era ta crip			•	Elevation
)ep	san ype			•		Pen.	Rec.	RQD	Genera Strata Descri		and Notes	5	eve
	υ, <u>Γ</u>		per (o in	ches		<u> </u>	1 12		<u> </u>			<u> </u>
0 ¬									DAVENTENT	4" A a m la a	It Oll Company		 ⊢ 15
1									PAVEMENT STRUCTURE	4 Aspna	It 8" Concrete		
_									MISCELLANEOU	s e			
5 -	S-1	_	E	-	4				FILL	Brown C	F GRAVEL and C-I	ESAND treilt	10
1		5	ວ	ວ	4	24	4			DIOWII C.	TOTAVEL AND U-I	OAND, II SIII	l
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10 -	\S-2 /	50				3	2			Brown C-	F GRAVEL, little f-c	Sand tr Silt	<u> </u>
4	\ <u>\\</u>									w/cobble		o dana, tr dit	l
									WEATHERED	1			Ŀ
15 -	S-3	3	6	8	2	24	10		BEDROCK	Dark Gra	y C-F SAND and C	-F GRAVEL tr	- o
4	0-3	٥	ь	0	2	24	10			Silt	y O-1 OAND and O	-i Orvavee, u	
_	C-1									Dark Gra	y BASALT fine grai	nod laminatod	
20 -	0-1					60	10	0		bedding I	nighly fractured sligl		-5
4							10	"		and stron	g		F
25 –	S-4	50	50			8	7			Brown C-	F Gravel, little Silt,	tr f-c Sand	-10
-											,		F
4													l
30 -	C-2									Gray BAS	SALT fine grained m	nedium bedded	-15
-						60	42	22		highly fra Strong	ctured moderately v	weathered and	
_										Chong			F
35 -	C-3								BEDROCK		DSTONE medium		-20
_						60	57	95			bedding moderately eathered and extre		F
₄₀ -													F
40 _										Bottom of B	oring		1
	Sar	nple	Тур	e:	S=S	plit Sr	oon	C=Cc	ore UP = Undistu	ırbed Pist	on V = Vane Sh	ear Test	•
		•	٠.						Little = 10 - 20%,				
Tota	l Pene								t wash at 10 ft		,	Sheet	
	h: 30			10					at 12.3ft, 6 in col	oble at 18	ft dense	1 of 1	
	of Sam								alternating wash			014.004.11.	4.10.0
INU. (u Sain	pies.	. 1									SM-001-M REV.	1/02

					C
				THE INFORMATION, INCLUDING ESTIMATED QUANTITIES OF WORK, SHOWN ON THESE SHEETS IS BASED ON LIMITED INVESTIGATIONS BY THE STATE AND IS IN NO WAY WARRANTED TO INDICATE THE CONDITIONS OF ACTUAL QUANTITIES OF WORK WHICH WILL BE REQUIRED.	C
REV.	DATE	REVISION DESCRIPTION	SHEET NO.	Plotted Date: 11/18/2014	l

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	BLOCK:	
)	OFFICE OF ENGINEERING	
	APPROVED BY:	
	h/sll Butterl	
	WWW The state of t	ı

REHABILITATION OF BRIDGE NO. 01665
AND INTERSECTION REALIGNMENT
OF ROUTE 100 AT U.S. ROUTE 1

PROJECT NO.

43-128

DRAWING NO.

BOR-02

SHEET NO.

03.03


BORING REPORT

_				Driller: T. Mallory						DOT Boring Re	Hole No.: RW-1			
Inspector: G. Arzt Engineer: Brett McKiernan					Town: EAST HAVEN					Stat./Offset:14+15/53ft LT				
								3-0128		 	1752.404			
	<u> Date:</u>								100			 	3920.789	
	h Date				Jaia D	•			: 016	65		Surface Elevati	ion: 7.36	
	ect Des);00_4_0/0;		O DI T	NO2	
	ng Size				VV					Size:SS 1 3/8in		Core Barrel Ty	pe:NQ2	
	<u>ımer W</u> ındwat			all: Wati	one /	•			<u>/t.:14</u> `		ter hou	rs, @ after	hours	
Oloc	inawat	<u> </u>		MP		<u>w,z</u>	<u>. i a</u>	iter c	,	' `-'		15, (<i>w</i>) arter	Hours	Œ
(ft)	ω o.		Blo	WS	on		(in.)	(in.)	\o	Generalized Strata Description		Material Desc	rintion	
Depth (ft)	Sample Type/No.		Sa	mpl	er				% 0	era Ita crij		and Notes	•	Elevation
Эер	Sar ype			•	ches		Pen.	ec.	RQD	sen Stra Oes		and Notes	•	<u> </u>
	<u> </u>		pei	0 111	CHES		<u>ш</u>	A.	"	000				НШ
0]										MISCELLANEOUS	1			
]										FILL]			5
1														L
5 –	S-1	3	2	2	6		24	2			Brown C-	F GRAVEL, little c-	f Sand, little	-
-			_	_	Ū		- '	_			Silt, w/co		,	⊩ o
_]														
10 -	S-2	16	19	33	67		24	13		WEATHERED BEDROCK	Dark Gra	y C-F GRAVEL, tr f	-c Sand, tr Silt	Ŀ
										BEDROCK				-5
4.5														
15 -	S-3	18	42	50			13	10				y C-F GRAVEL, litt	le Silt, tr. f-c	L
										DEDDOOK	Sand			-10
	C-1						00	40		BEDROCK	Dark Gra	y BASALT coarse <u>(</u>	rrained	
20 -							60	12	0		laminated	d bedding highly fra d and strong		- - 15
25 -	C-2						60	20	0		laminated	y BASALT coarse of bedding highly fra Bly weathered and r	ctured	-
-														上 ₋₂₀
·											Bottom of B	oring		7
	Sar	nple	Typ	e:	S=S	plit	Spc	on (: C=Co	re UP = Undistu	rbed Pist	on V = Vane Sh	ear Test	I
		•	٠.			•	•			_ittle = 10 - 20%,				
Tota	I Pene									ft soil became de		·	Sheet	
	h: 17.5						_ I			l in wash	, gido	- 4.14	1 of 1	
							+							
110.	of Sam	pies	. ວ										SM-001-M REV.	1/02

THE INFORMATION, INCLUDING ESTIMATED QUANTITIES OF WORK, SHOWN ON THESE SHEETS IS BASED ON LIMITED INVESTIGATIONS BY THE STATE AND IS IN NO WAY WARRANTED TO INDICATE THE CONDITIONS OF ACTUAL QUANTITIES OF WORK WHICH WILL BE REQUIRED.	DESIGNER/DRAFTER: JS CHECKED BY: PM DEPARTMENT OF TRANSPORTATION	SIGNATURE/ BLOCK: OFFICE OF ENGINEERING APPROVED BY:	REHABILITATION OF BRIDGE NO. 01665 AND INTERSECTION REALIGNMENT OF ROUTE 100 AT U.S. ROUTE 1	TOWN: EAST HAVEN DRAWING TITLE: BORING REPORT	PROJECT NO. 43-128 DRAWING NO. BOR-03 SHEET NO. 03.04
REV. DATE REVISION DESCRIPTION SHEET NO. Plotted Date: 11/18/2014	Filename:\HW_MST_0043_0128_Boring.dgn	Will I SWAM			05.04

GENERAL NOTES:


- 1. MAXIMUM SLOPES OF ADJOINING GUTTERS AND ROAD SURFACES IMMEDIATELY ADJACENT TO THE SIDEWALK RAMP SHOULD NOT EXCEED 5%. THE MAXIMUM GRADE DIFFERENCE BETWEEN THE GUTTER AND CURB RAMP SHALL NOT EXCEED 13%. SEE DETAIL 1 ON MDS-02.
- 2. RAMP GRADE SHALL BE UNIFORM, FREE OF SAGS AND ABRUPT GRADE CHANGES. RUNNING SLOPES OF RAMPS SHALL NOT EXCEED 8.33% AND SHALL NOT EXCEED 15' (4.5m) WITHOUT PROVIDING A LANDING.
- 3. ALL RAMPS SHALL BE CONSTRUCTED OF CLASS "F" CONCRETE IN ACCORDANCE WITH CONNECTICUT STANDARD
- SPECIFICATIONS. 4. SIDEWALK RAMPS SHALL HAVE A COARSE BROOM FINISH TRANSVERSE TO THE SLOPE OF THE RAMP. THE SURFACE OF
- ALL SIDEWALK RAMPS SHALL BE STABLE, FIRM AND SLIP RESISTANT. SURFACE DISCONTINUITIES SHALL NOT EXCEED $\frac{1}{2}$ " (13) MAX. VERTICAL DISCONTINUITIES BETWEEN $\frac{1}{4}$ " (6.4) AND $\frac{1}{2}$ " (13) MAX. SHALL BE BEVELED 1:2 MINIMUM APPLIED ACROSS THE ENTIRE LEVEL CHANGE.
- 5. DIAGONAL SIDEWALK RAMPS AT MARKED CROSSINGS SHALL BE WHOLLY CONTAINED WITHIN THE MARKINGS, EXCLUDING ANY FLARED SIDES DIAGONAL AND PERPENDICULAR RAMPS SHALL HAVE THE RAMP CUT PERPENDICULAR TO THE TANGENT OF THE CURB RADIUS FOR THE DESIGNATED ACCESSIBLE ROUTE. BOTH LONGITUDINAL SIDES OF THE RAMP SHOULD BE THE SAME LENGTH. SKEWED RAMPS SHOULD BE AVOIDED. FLARES ARE NOT CONSIDERED PART OF PEDESTRIAN ACCESS ROUTE. DIAGONAL RAMPS SHOULD NOT BE INSTALLED WHERE CURB RADII IS LESS THAN 20'(6096).
- 6. REMOVAL OF EXISTING SIDEWALK FOR NEW RAMP INSTALLATIONS SHALL BE TO THE NEAREST EXPANSION OR CONTRACTION JOINT. 8.3% MAXIMUM SLOPE MAY NOT BE ACHIEVABLE DUE TO EXISTING SIDEWALK GRADE. IN RECOGNITION OF THIS, A LIMIT OF 15' (4572) FOR REMOVAL SHALL BE USED UNLESS OTHERWISE SHOWN ON THE PLANS OR DIRECTED BY THE ENGINEER. SAW CUT REQUIRED FOR DUMMY JOINTS SHALL BE INCLUDED IN THE COST OF "CONCRETE SIDEWALK RAMP" OR "CONCRETE SIDEWALK".
- 7. EXPANSION JOINTS IN CONCRETE SHALL MATCH THOSE IN ADJACENT SIDEWALKS BUT IN NO CASE SHALL THE SPACING BETWEEN EXPANSION JOINTS EXCEED 12' (3658) UNLESS OTHERWISE NOTED.
- 8. CONCRETE SIDEWALK RAMPS, SHALL BE PAID FOR UNDER THE ITEM "CONCRETE SIDEWALK RAMP", AS DEFINED BY THE CONSTRUCTION LIMITS ON THE PLANS AND SHALL BE FIELD VERIFIED.
- 9. SIDEWALK RAMPS SHALL BE CONSTRUCTED WITH THE TOE AT THE GUTTER CAST INTEGRALLY WITH RAMP UNLESS DIRECTED OTHERWISE BY THE ENGINEER (SEE TYPICAL SECTION BELOW). CURB REMOVAL AND CAST IN PLACE CURBING REQUIRED FOR THE RAMP, SHALL BE INCLUDED WITH PAY ITEM "CONCRETE SIDEWALK RAMP"
- CURBING OUTSIDE LIMITS OF RAMP OR LANDING SHOWN BELOW SHALL BE CONSTRUCTED AND PAID FOR IN ACCORDANCE WITH CONNECTICUT STANDARD SPECIFICATIONS.
- 10. PREFERRED LOCATION TO INSTALL DETECTABLE WARNING STRIP SHALL BE 6" (152) FROM THE EDGE OF ROAD ALONG THE FULL WIDTH OF THE RAMP. FOR ALTERNATE LOCATIONS, REFER TO DETECTABLE WARNING PLACEMENT DETAILS ON
- 11. TO PERMIT WHEELCHAIR WHEELS TO ROLL BETWEEN DOMES, ALIGN DOMES ON A SQUARE GRID IN THE DIRECTION OF RUNNING SLOPE (PERPENDICULAR TO CURB OR SLOPE BREAK). THE TRANSITION FROM RAMP TO GUTTER SHALL BE FLUSH WITHOUT A LIP.
- 12. WHERE COMMERCIAL DRIVEWAYS ARE PROVIDED WITH TRAFFIC SIGNALS AND THE SIDEWALK IS CONTINUOUS THROUGH DRIVEWAY, DETECTABLE WARNINGS ARE REQUIRED AT THE JUNCTION BETWEEN THE PEDESTRIAN ROUTE AND DRIVEWAY.
- 13. CONSTRUCT A SIDEWALK CURB WHEN THERE IS INSUFFICIENT BUFFER AVAILABLE TO GRADE OR
- WHEN CALLED FOR IN PLANS. PAID FOR WITH SIDEWALK RAMP WHEN REQUIRED FOR RAMP. 14. THE TOP AND BOTTOM OF RAMPS SHOULD BE PROVIDED WITH A 4'x 4' (1219 x 1219) MINIMUM LEVEL LANDING AREA WITH A CROSS SLOPE LESS THAN OR EQUAL TO 2% IN ANY DIRECTION.
- 15. UTILITY POLES, LUMINAIRE, PEDESTRIAN OR SIGNAL POLES, GRATES, ACCESS COVERS, AND OTHER APPURTENANCES SHALL NOT BE LOCATED ON RAMPS, LANDINGS, BLENDED TRANSITIONS, AND @ GUTTERS WITHIN THE PEDESTRIAN ACCESS ROUTE.
- 16. APPROACH SIDEWALK WIDTHS, GRASS STRIP OR UTILITY STRIP WIDTHS MAY VARY. 17. APPROACH SIDEWALK AND LANDING CROSS SLOPE SHALL NOT EXCEED 2%.
- 18. THE RUNNING OR CROSS SLOPES ON LANDINGS AT MID BLOCK CROSSING MAY BE WARPED TO MEET STREET OR HIGHWAY GRADE.
- 19. FOR PERPENDICULAR CURB RAMPS A MIN. 4'(1.2m) x 4'(1.2m) LEVEL LANDING SHALL BE PROVIDED AT THE TOP OF CURB RAMP. WHERE THE LEVEL LANDING IS RESTRICTED AT THE BACK OF SIDEWALK THE LEVEL LANDING SHALL BE 4'(1.2m) x 5'(1.5m) WITH THE 5'(1.5m) DIMENSION PROVIDED IN THE DIRECTION OF THE RAMP RUN.
- 20. FOR PARALLEL CURB RAMPS, A MIN. $4'(1.2m) \times 4'(1.2m)$ LEVEL LANDING SHALL BE PROVIDED AT THE BOTTOM OF CURB RAMP, IF THE LEVEL LANDING IS RESTRICTED ON 2 OR MORE SIDES, THE LEVEL LANDING SHALL BE 4'(1,2m)x 5'(1,5m) WITH THE 5'(1.5m) DIMENSION PROVIDED IN THE DIRECTION OF THE PEDESTRIAN STREET CROSSING.
- 21. WHEN WIDTH OF SIDEWALK IS ≥48" AND A PERPENDICULAR SIDEWALK RAMP IS INSTALLED, THE FLARED SIDES SHALL BE 10% MAX. IF WIDTH OF SIDEWALK IS <48" THE FLARED SIDES MUST NOT EXCEED 8.33% (12:1).
- 22. SHADED AREAS ARE TYPICAL PAY LIMITS FOR CONCRETE SIDEWALK RAMP BUT, MAY VARY AS DIRECTED BY THE ENGINEER 23. OPTIONAL RAMP, WHEN REQUIRED, SHALL BE PAID FOR AS PART OF CONCRETE SIDEWALK RAMP.

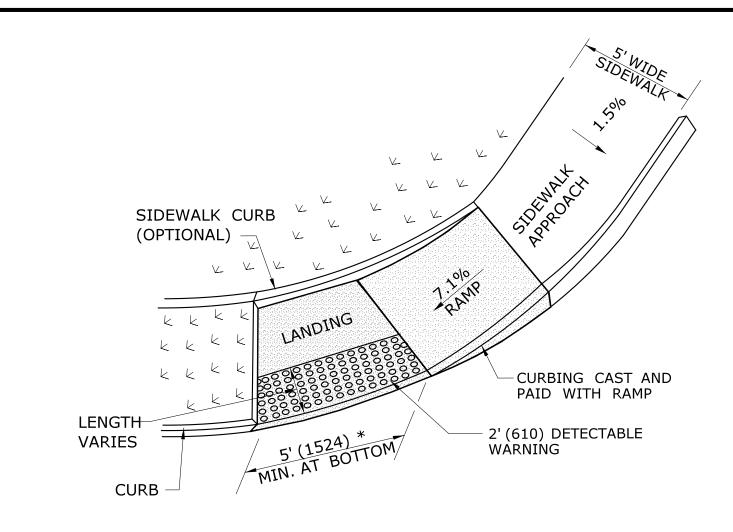


SINGLE PARALLEL SIDEWALK RAMP W/LANDING AT BOTTOM ON

CORNER (TYPE 4c)

* SEE NOTE 20

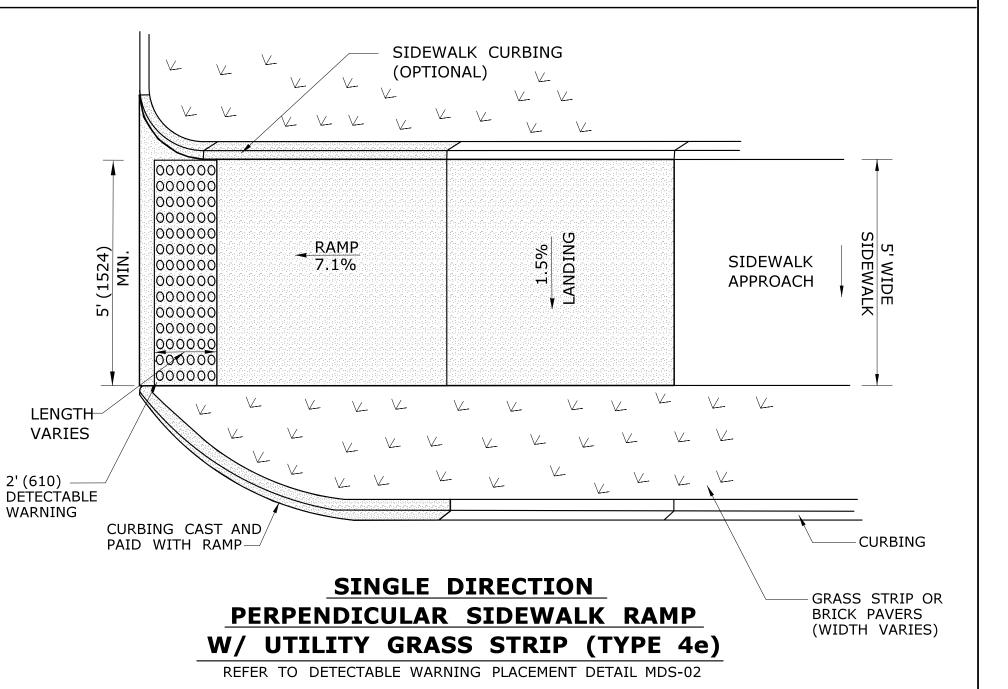


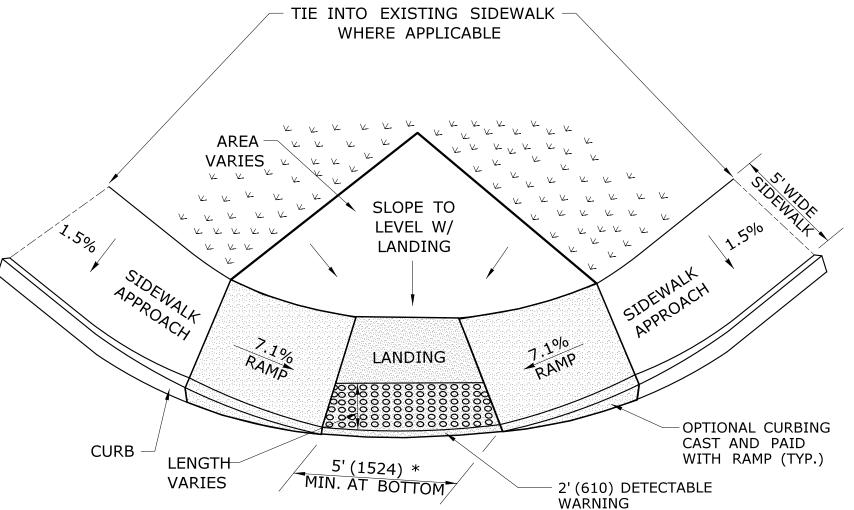

DOUBLE PARALLEL SIDEWALK RAMP W/LANDING AT BOTTOM ON CORNER (TYPE 4f)


* SEE NOTE 20

ALL METRIC DIMENSIONS ARE IN MILLIMETERS (mm) UNLESS OTHERWISE NOTED

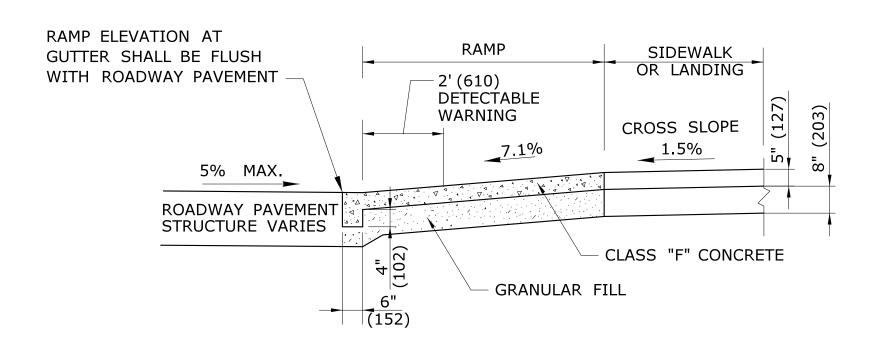


TYPICAL SECTION THRU SIDEWALK RAMP

SEE NOTES 2 AND 17

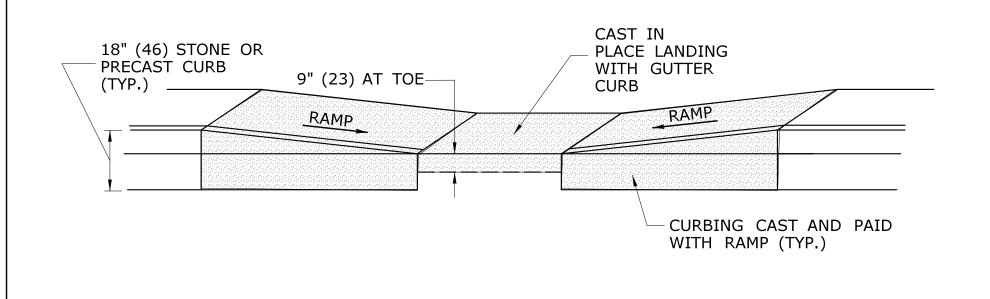

TYPICAL ELEVATION PARALLEL SIDEWALK RAMP WITH CAST IN PLACE GUTTER

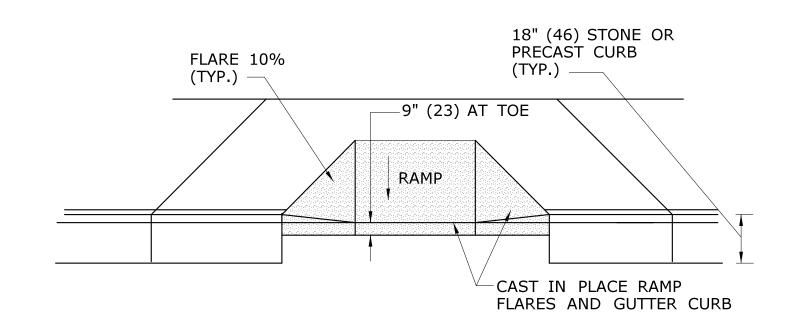

TYPICAL ELEVATION PERPENDICULAR SIDEWALK RAMP

				THE INFORMATION, INCLUDING ESTIMATED
				QUANTITIES OF WORK, SHOWN ON THESE SHEETS IS BASED ON LIMITED
				INVESTIGATIONS BY THE STATE AND IS IN NO WAY WARRANTED TO INDICATE
				THE CONDITIONS OF ACTUAL QUANTITIES
				OF WORK WHICH WILL BE REQUIRED.
REV.	DATE	REVISION DESCRIPTION	SHEET NO.	Plotted Date: 1/5/2015

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SCALE AS NOTED

STATE OF CONNECTICUT DEPARTMENT OF TRANSPORTATION


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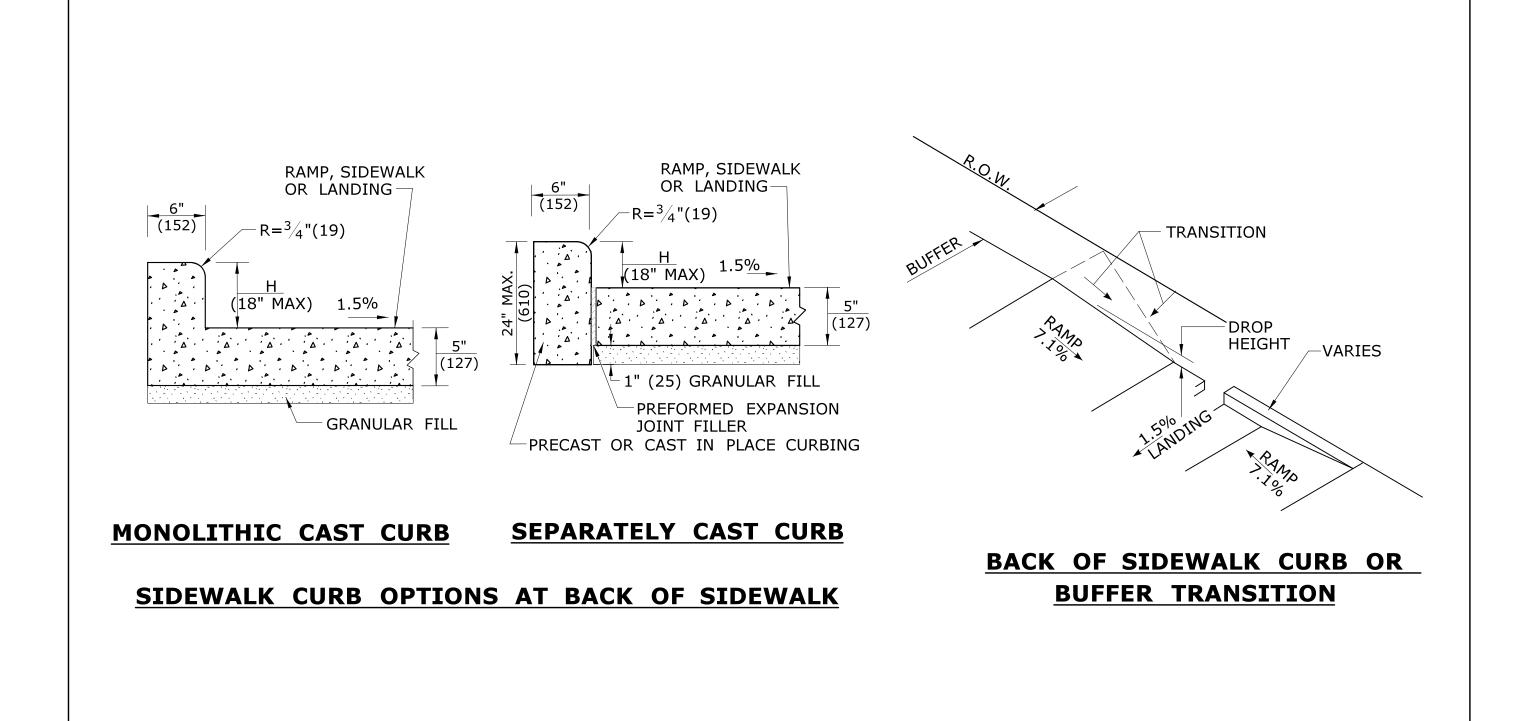
OFFICE OF ENGINEERING Will Butal

REHABILITATION OF BRIDGE NO. 01665 AND INTERSECTION REALIGNMENT OF ROUTE 100 AT U.S. ROUTE 1

EAST HAVEN
DRAWING TITLE:
MISCELLANEOUS DETAILS


43-128 MDS-01 03.05



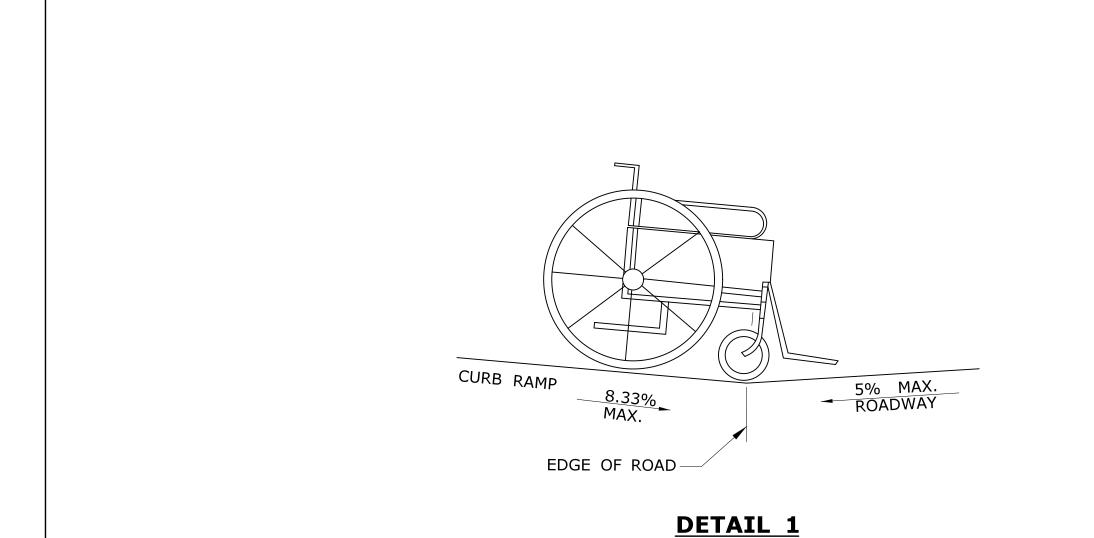


SEE GRADE CHANGE AT ROADWAY INTERFACE

SEE NOTE 1 MDS-01

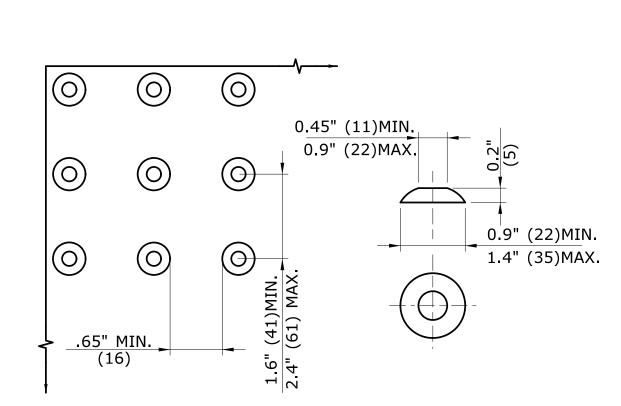

DOME SPACING DOME SECTION

STANDARD DOME ON DETECTABLE WARNING TILES

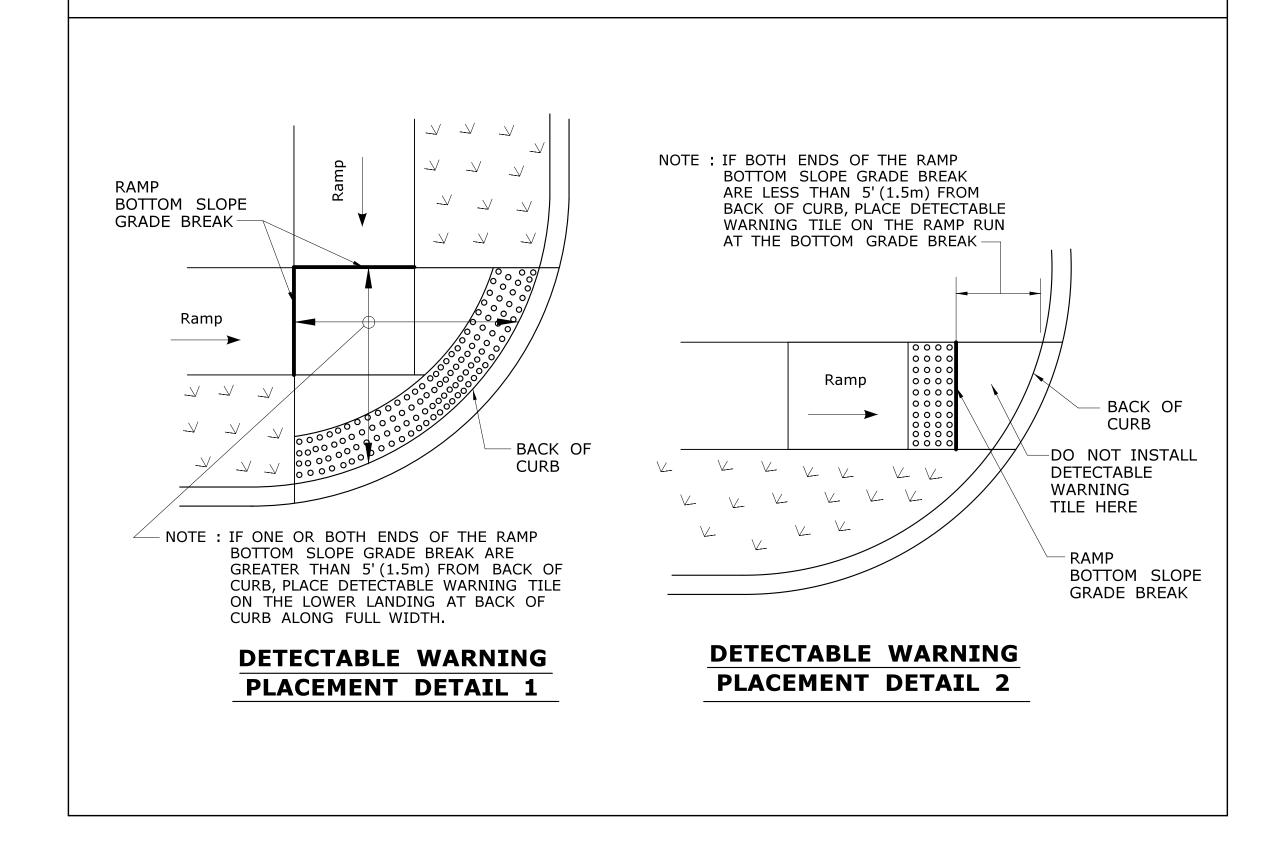



GENERAL NOTES:

1. SEE GENERAL NOTES ON MDS-01.


ALL METRIC DIMENSIONS ARE IN MILLIMETERS (mm) UNLESS OTHERWISE NOTED

THE INFORMATION, IN QUANTITIES OF WOR	CLUDING ESTIMATED CHECKED BY:	SIGNATURE/ BLOCK:	REHABILITATION OF BRIDGE NO. 0166!	EAST HAVEN	PROJECT NO. 43-128
SHEETS IS BASED O INVESTIGATIONS BY IN NO WAY WARRAN THE CONDITIONS OF	TED TO INDICATE	F TRANSPORTATION OFFICE OF ENGINEERING APPROVED BY:	AND INTERSECTION REALIGNMENT	DRAWING TITLE:	MDS-02
REV. DATE REVISION DESCRIPTION SHEET NO. Plotted Date: 11/18/2	SCALE AS NOTED	6/2ll Batal	OF ROUTE 100 AT U.S. ROUTE 1	MISCELLANEOUS DETAILS	SHEET NO. 03.06

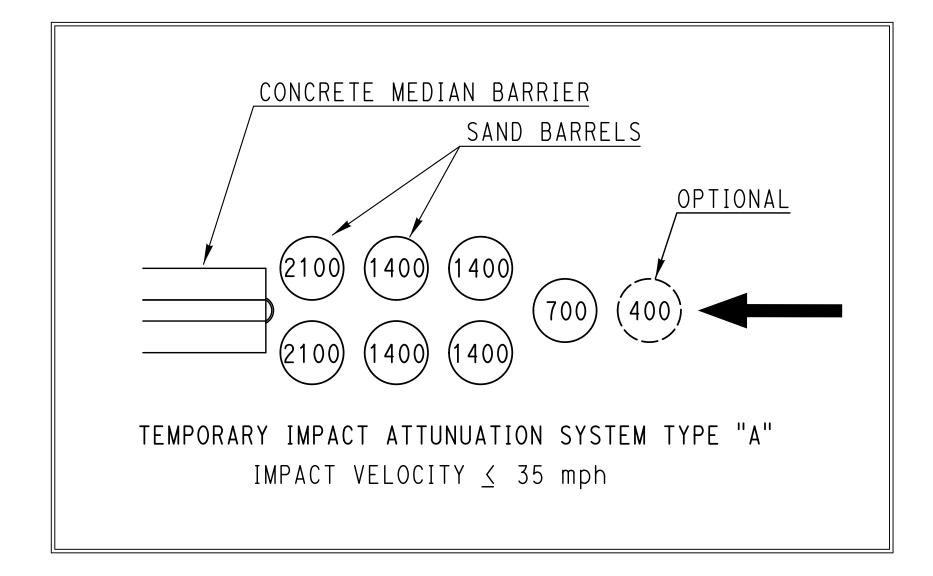

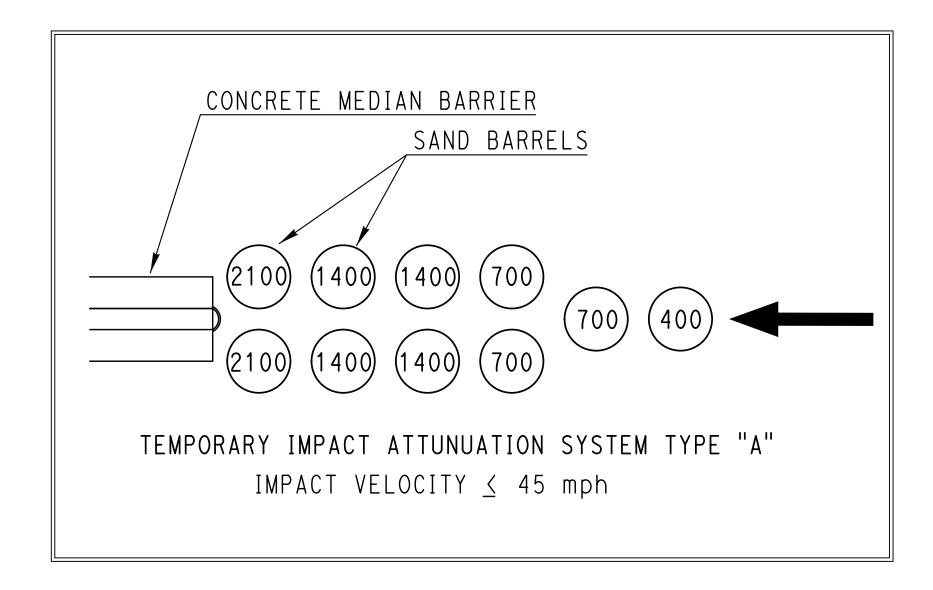



TEMPORARY IMPACT ATTENUATION SYSTEM TYPE "A" DETAIL (NOT TO SCALE)

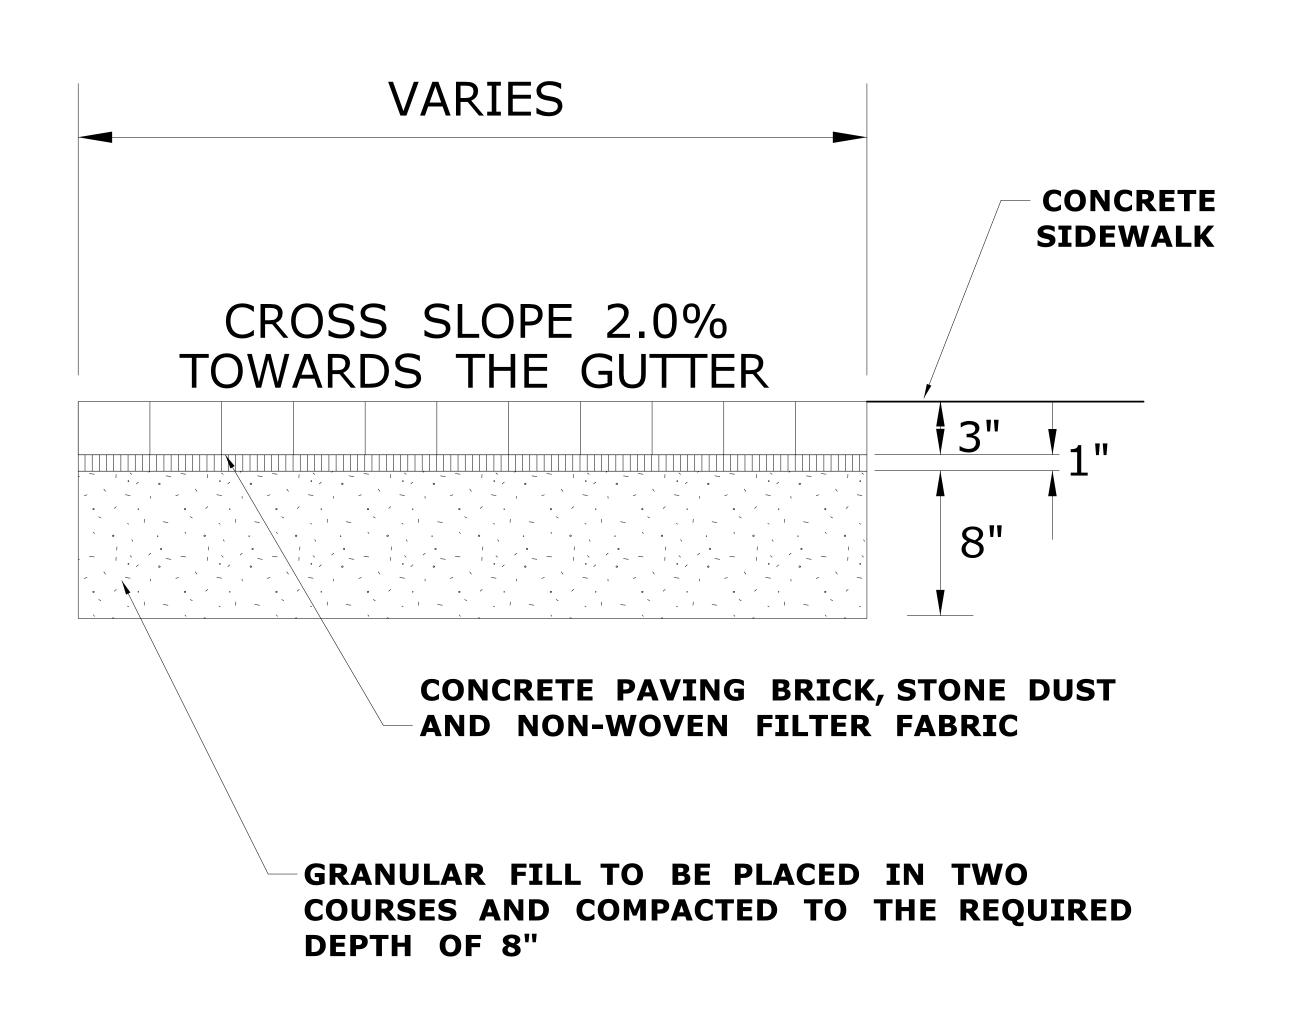

CONCRETE PAVING BRICK DETAIL (NOT TO SCALE)

THE INFORMATION, INCLUDING ESTIMATED QUANTITIES OF WORK, SHOWN ON THESE CHECK!	IGNER/DRAFTER: JB/JS CKED BY:	SIGNATURE/ BLOCK:	PROJECT TITLE: REHABILITATION OF BRIDGE NO. 01665	TOWN: EAST HAVEN	PROJECT NO. 43-128
SHEETS IS BASED ON LIMITED INVESTIGATIONS BY THE STATE AND IS IN NO WAY WARRANTED TO INDICATE THE CONDITIONS OF ACTUAL QUANTITIES	PM STATE OF CONNECTICUT (DEPARTMENT OF TRANSPORTATE	OFFICE OF ENGINEERING APPROVED BY:	AND INTERSECTION REALIGNMENT	DRAWING TITLE:	MDS-03
REV. DATE REVISION DESCRIPTION SHEET NO. Plotted Date: 11/18/2014	SCALE AS NOTED Filename:\HW_MST_0043_0128_MDS-03.dgn	Will Butterly	OF ROUTE 100 AT U.S. ROUTE 1	MISCELLANEOUS DETAILS	SHEET NO. 03.07

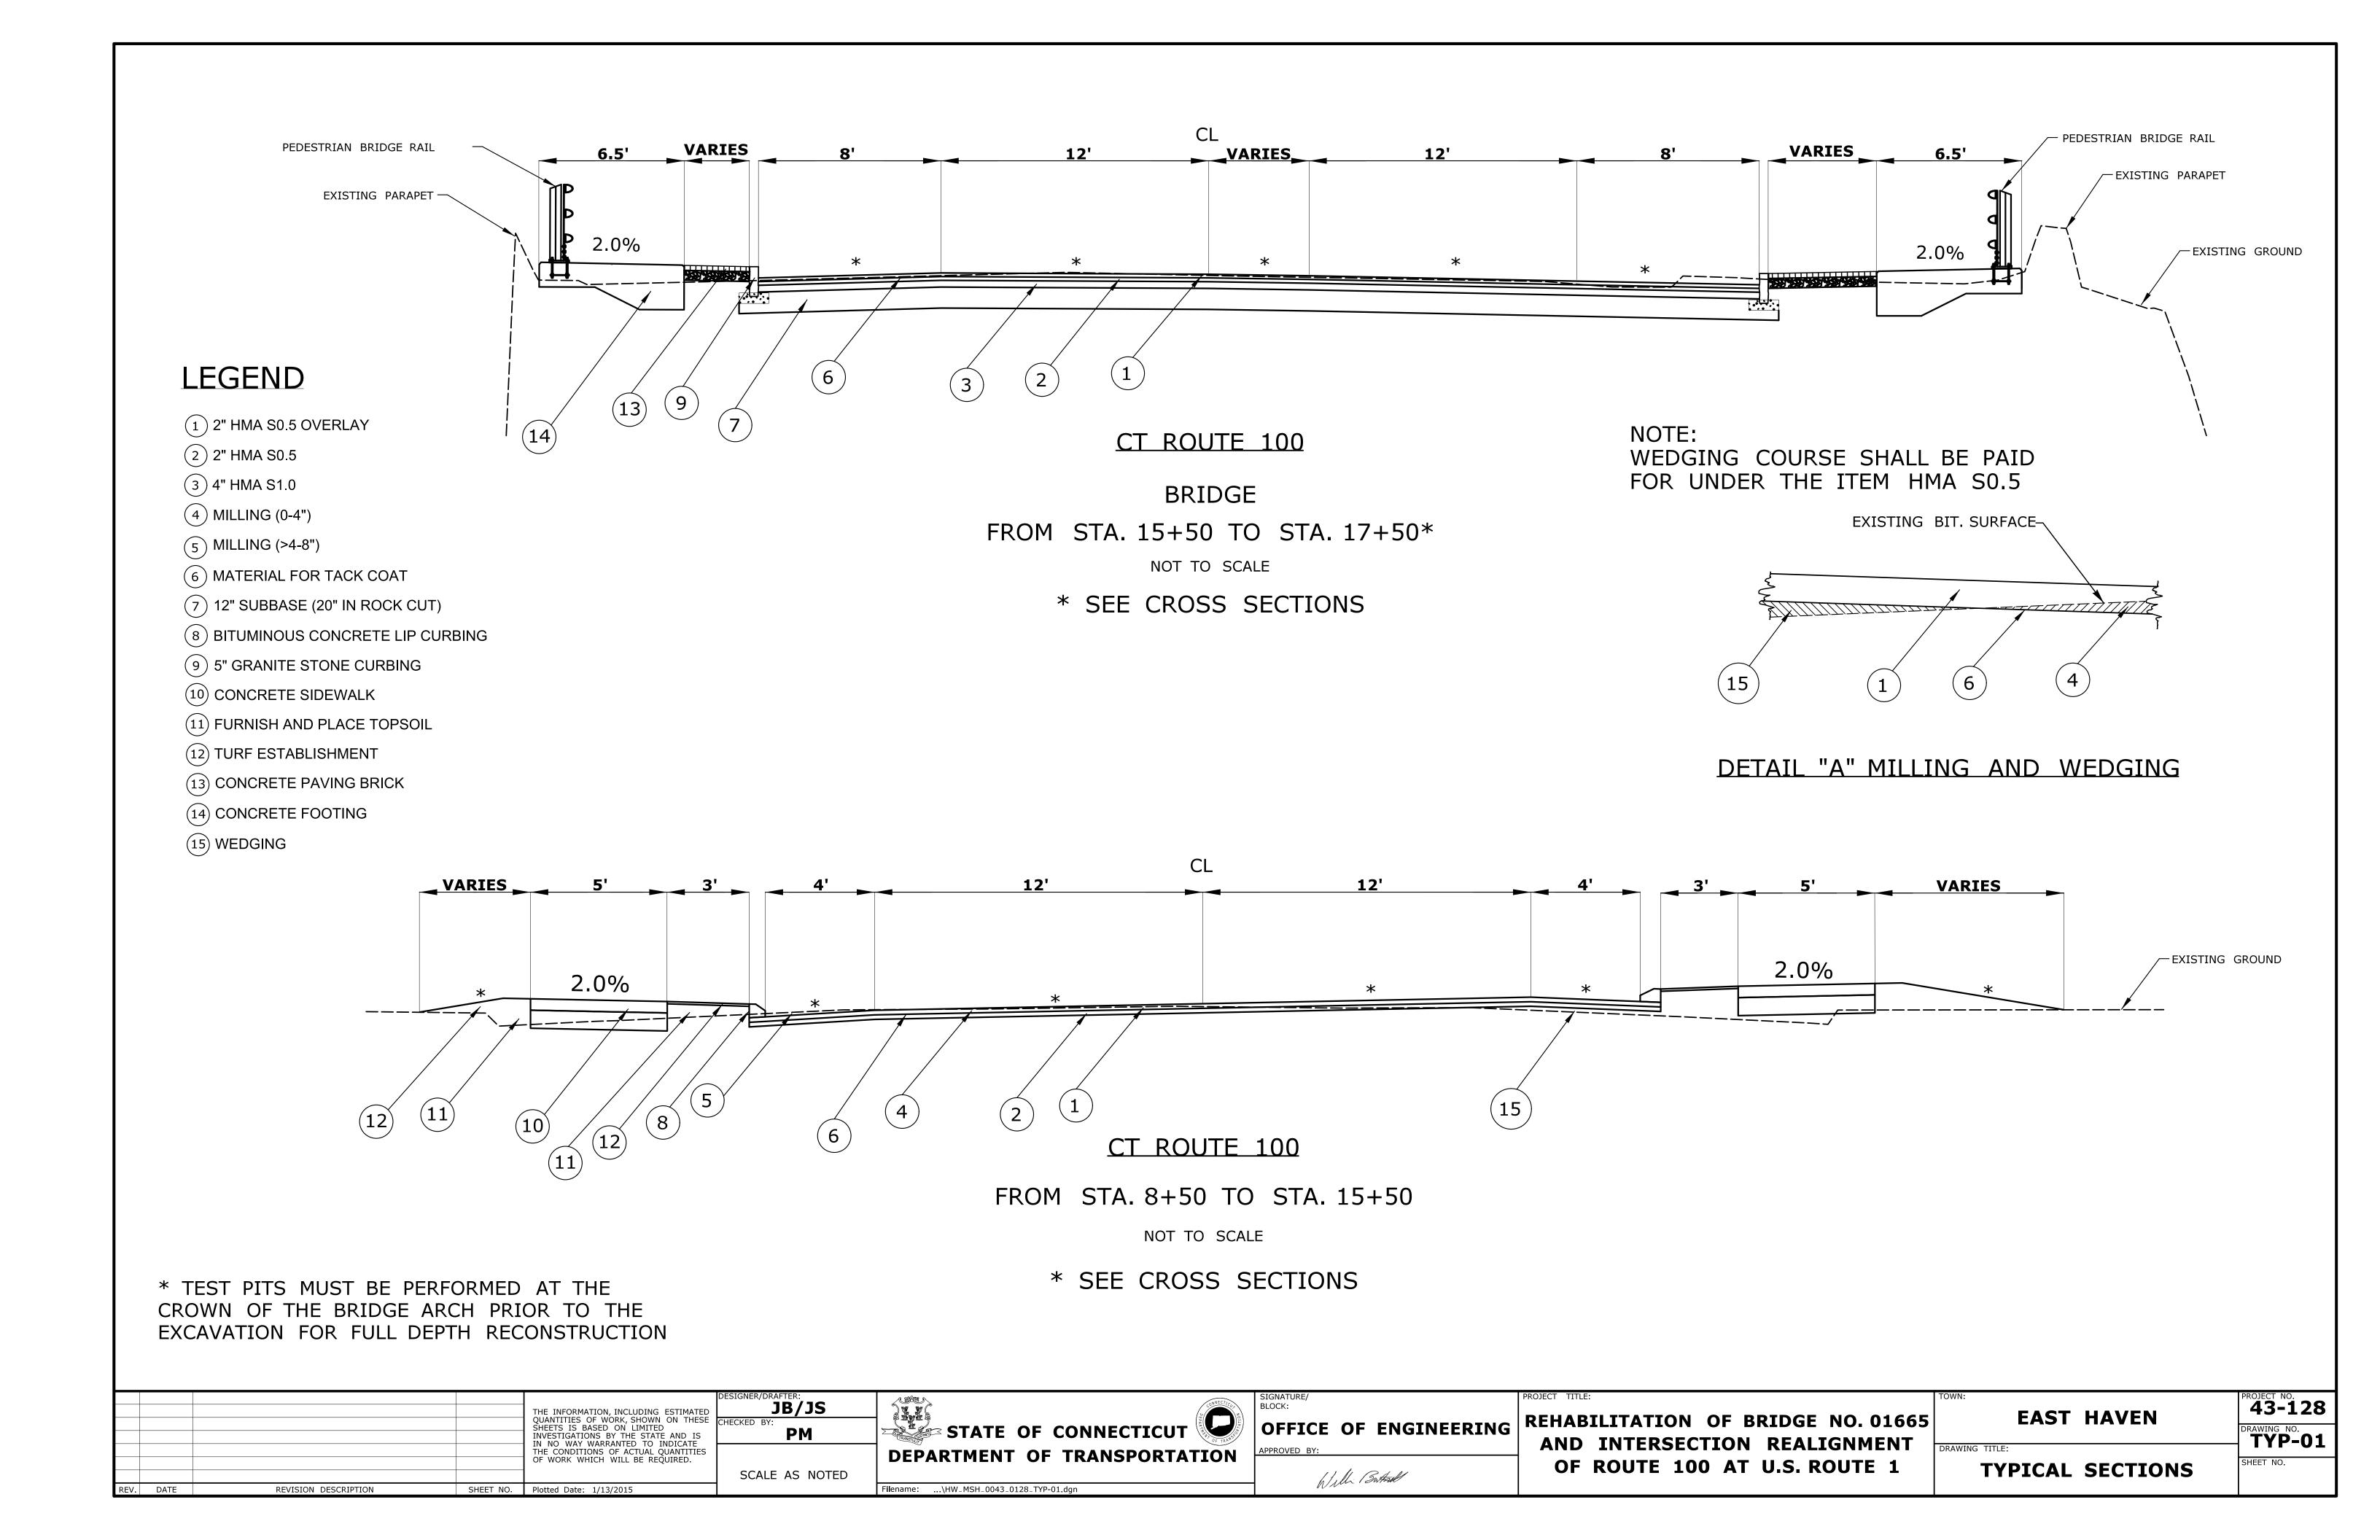

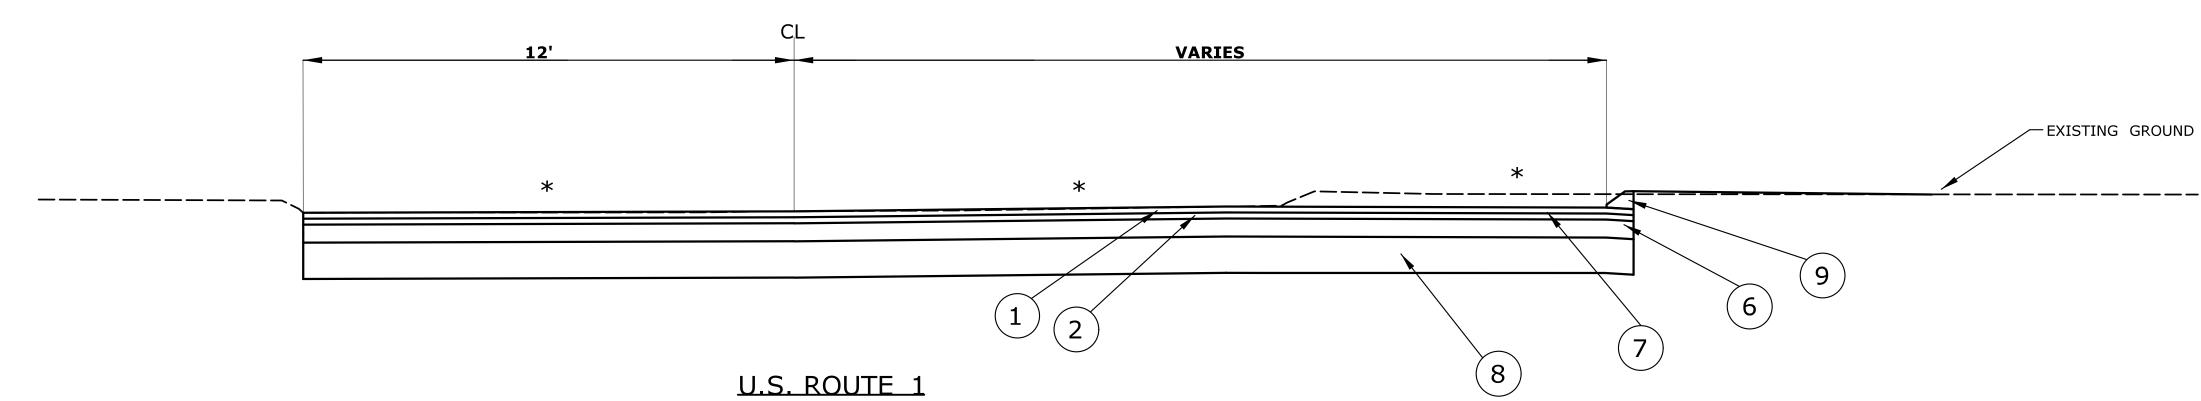

1 2" HMA S0.5 OVERLAY

2 2" HMA S0.5

LEGEND

3 4" HMA S1.0

4 MILLING (0-4")

5 MILLING (>4-8")

6 6" HMA S1.0

7 MATERIAL FOR TACK COAT

8 12" SUBBASE (20" IN ROCK CUT)

9 BITUMINOUS CONCRETE LIP CURBING

(10) CONCRETE SIDEWALK


11) FURNISH AND PLACE TOPSOIL

(12) TURF ESTABLISHMENT

FROM STA. 2+00 TO STA. 5+10

NOT TO SCALE


* SEE CROSS SECTIONS

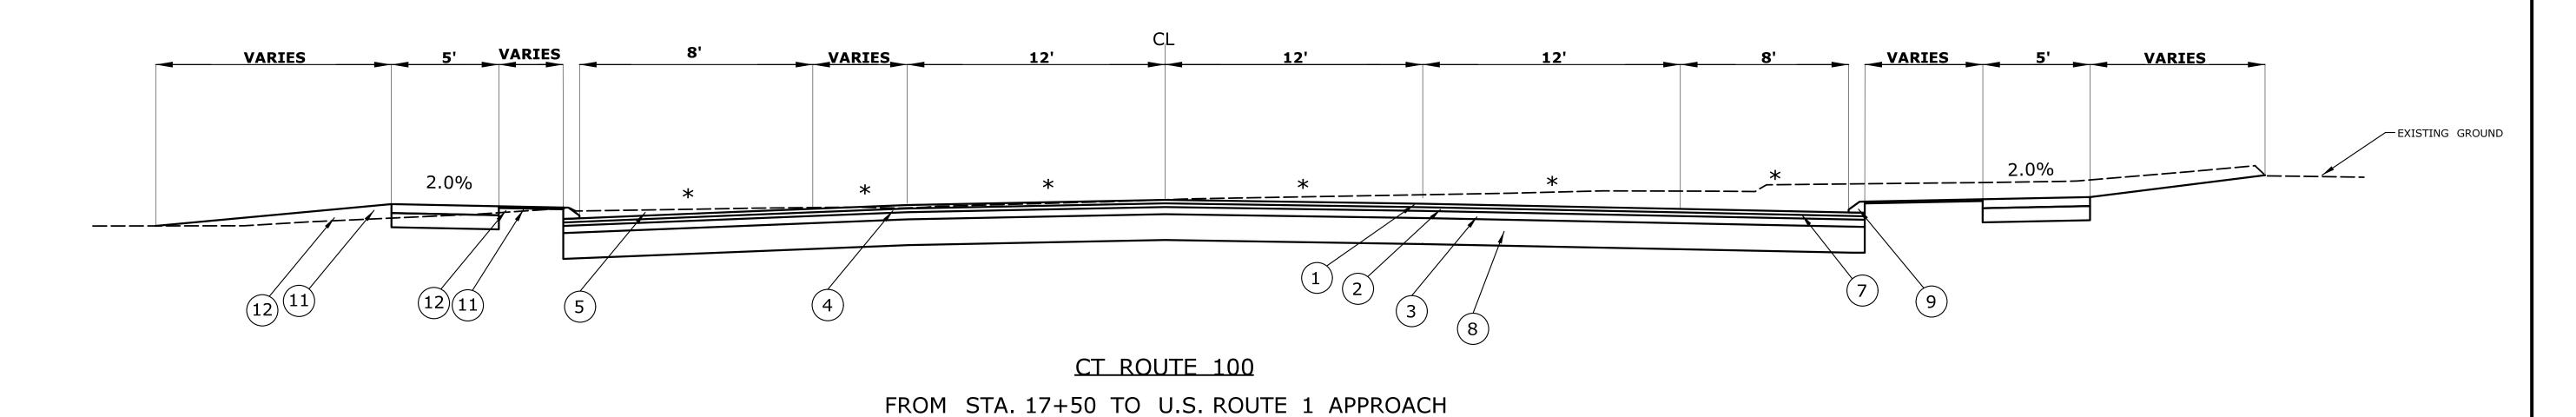



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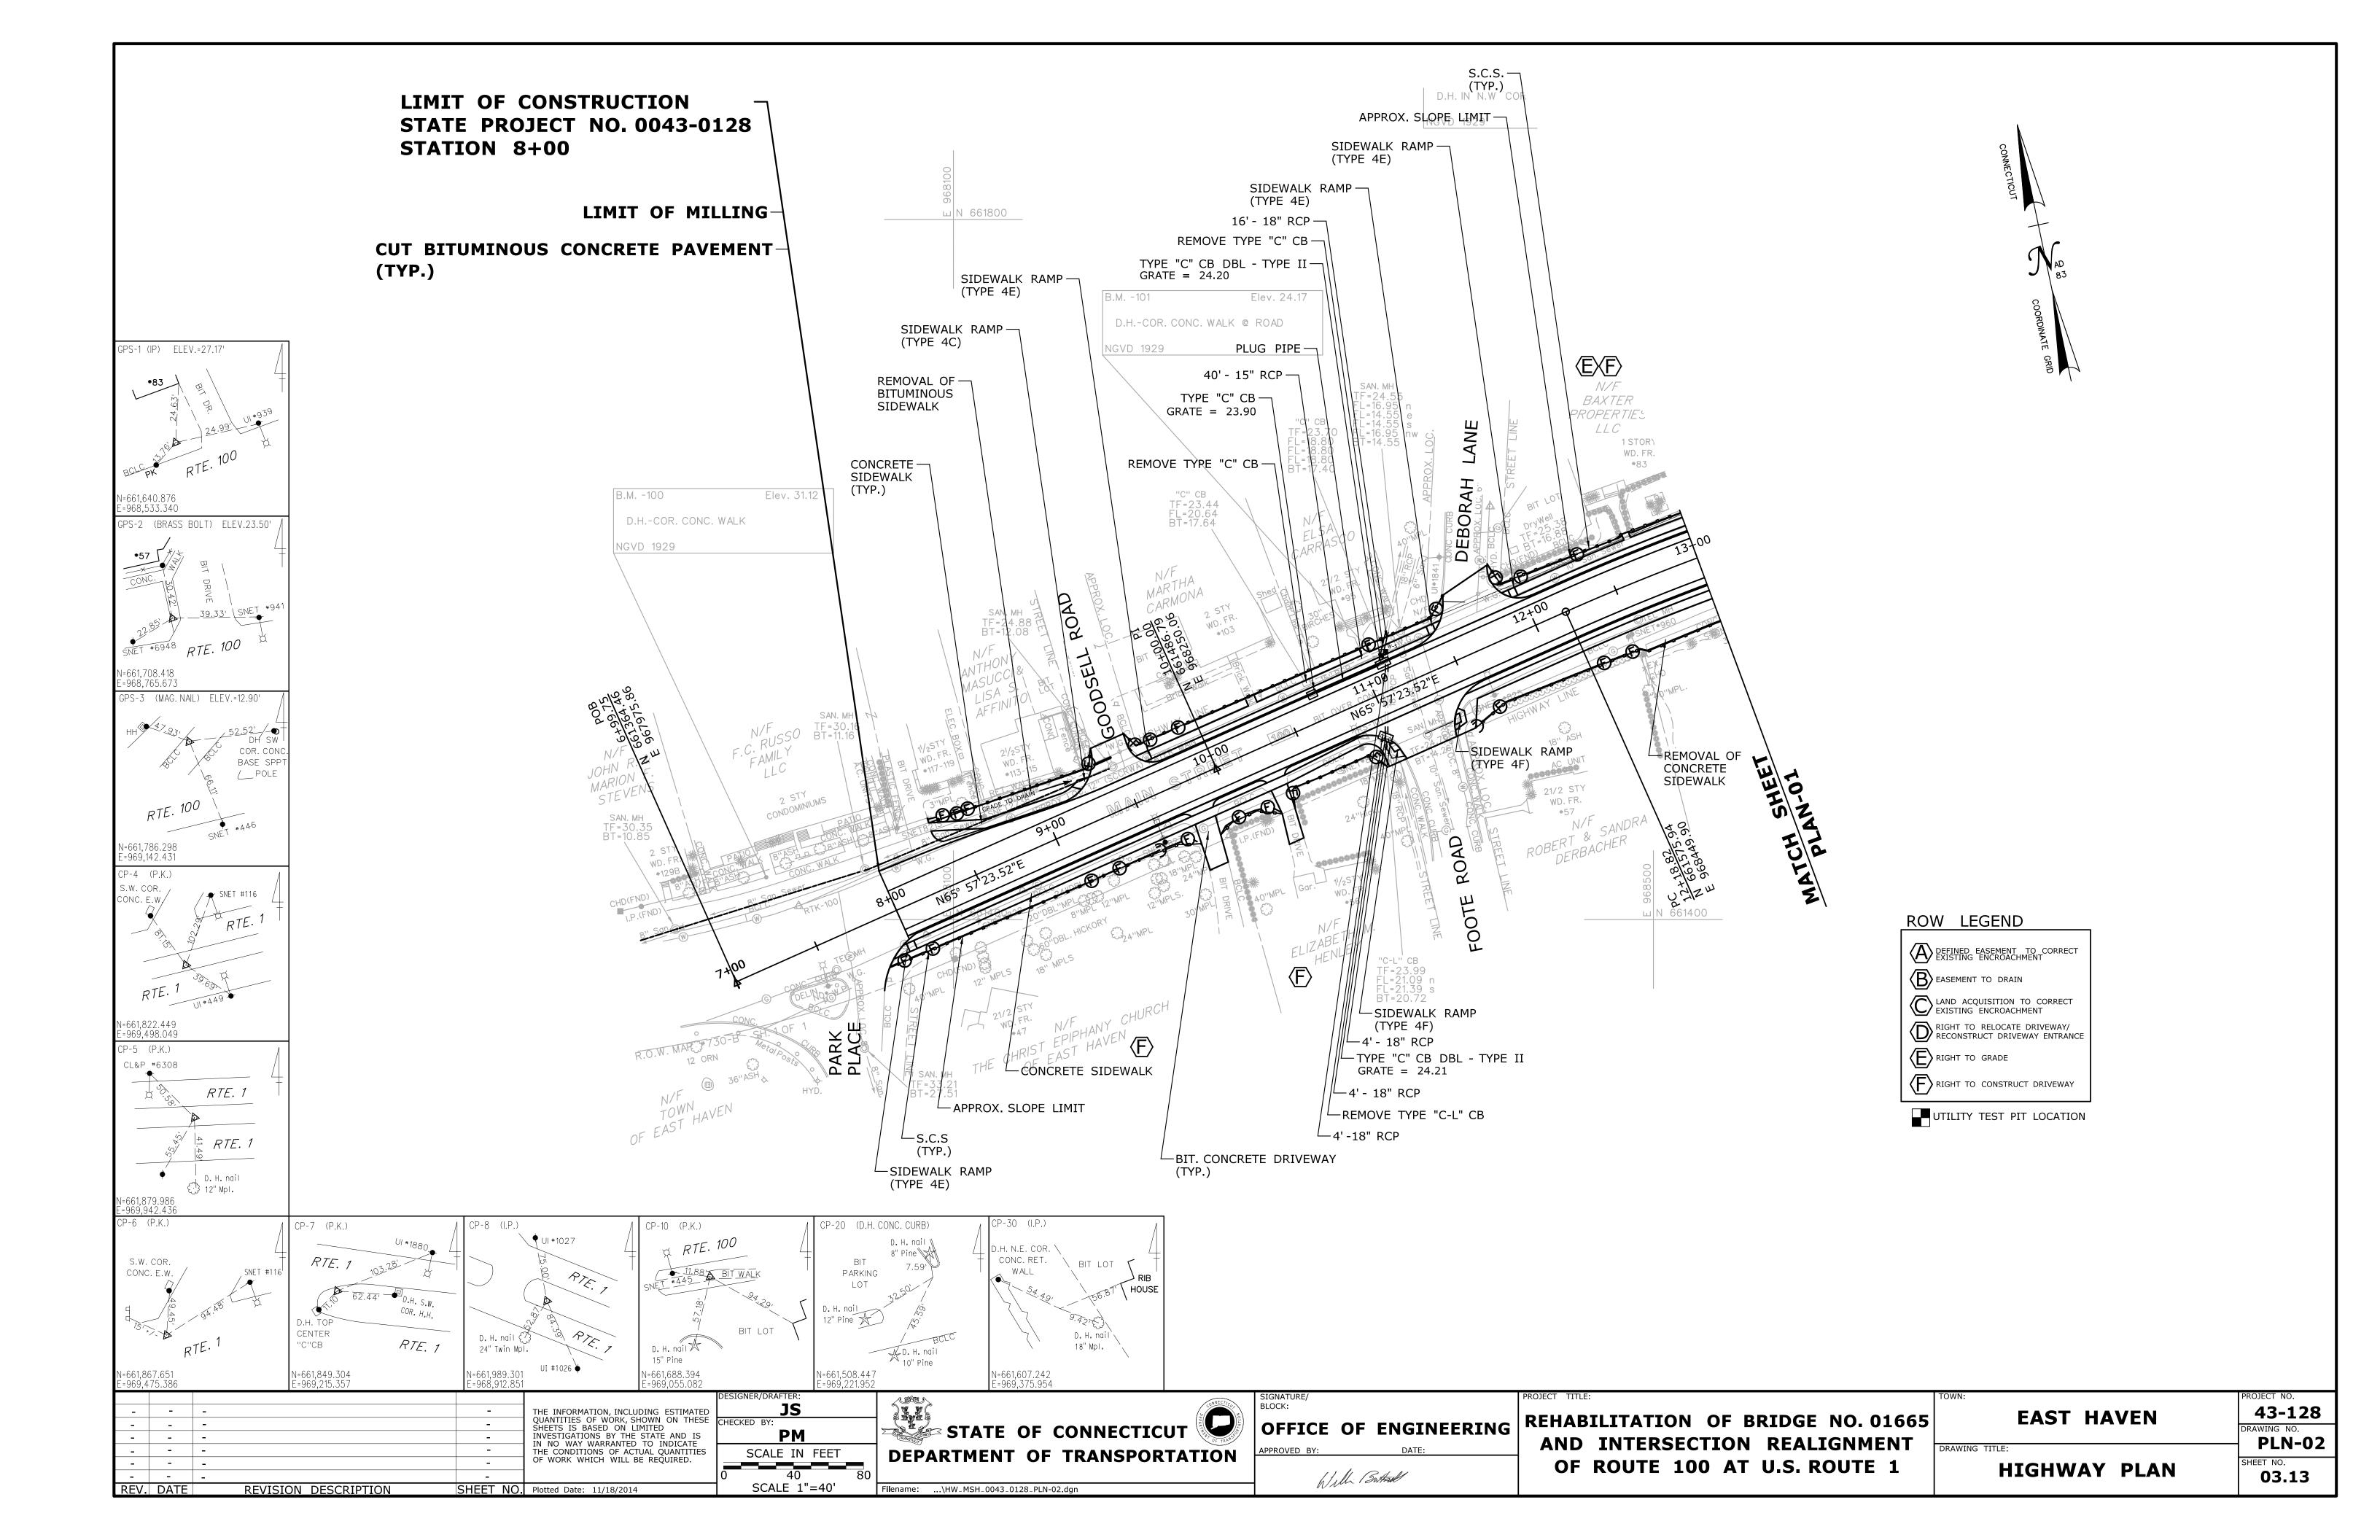
* SEE CROSS SECTIONS


THE INFORMATION, INCLUDING ESTIMATED QUANTITIES OF WORK, SHOWN ON THESE SHEETS IS BASED ON LIMITED INVESTIGATIONS BY THE STATE AND IS IN NO WAY WARRANTED TO INDICATE THE CONDITIONS OF ACTUAL QUANTITIES OF WORK WHICH WILL BE REQUIRED.	DEPARTMENT OF TRANSPORTATION	APPROVED BY:	REHABILITATION OF BRIDGE NO. 01665 AND INTERSECTION REALIGNMENT OF ROUTE 100 AT U.S. ROUTE 1	DRAWING TITLE:	PROJECT NO. 43-128 DRAWING NO. TYP-02 SHEET NO.
	SCALE AS NOTED	6/1 Controll	OF ROUTE 100 AT 0.5. ROUTE 1	TYPICAL SECTIONS	03.09
REV. DATE REVISION DESCRIPTION SHEET NO. Plotted Date: 11/18/2014	Filename:\HW_MSH_0043_0128_TYP-02.dgn	W Notes			




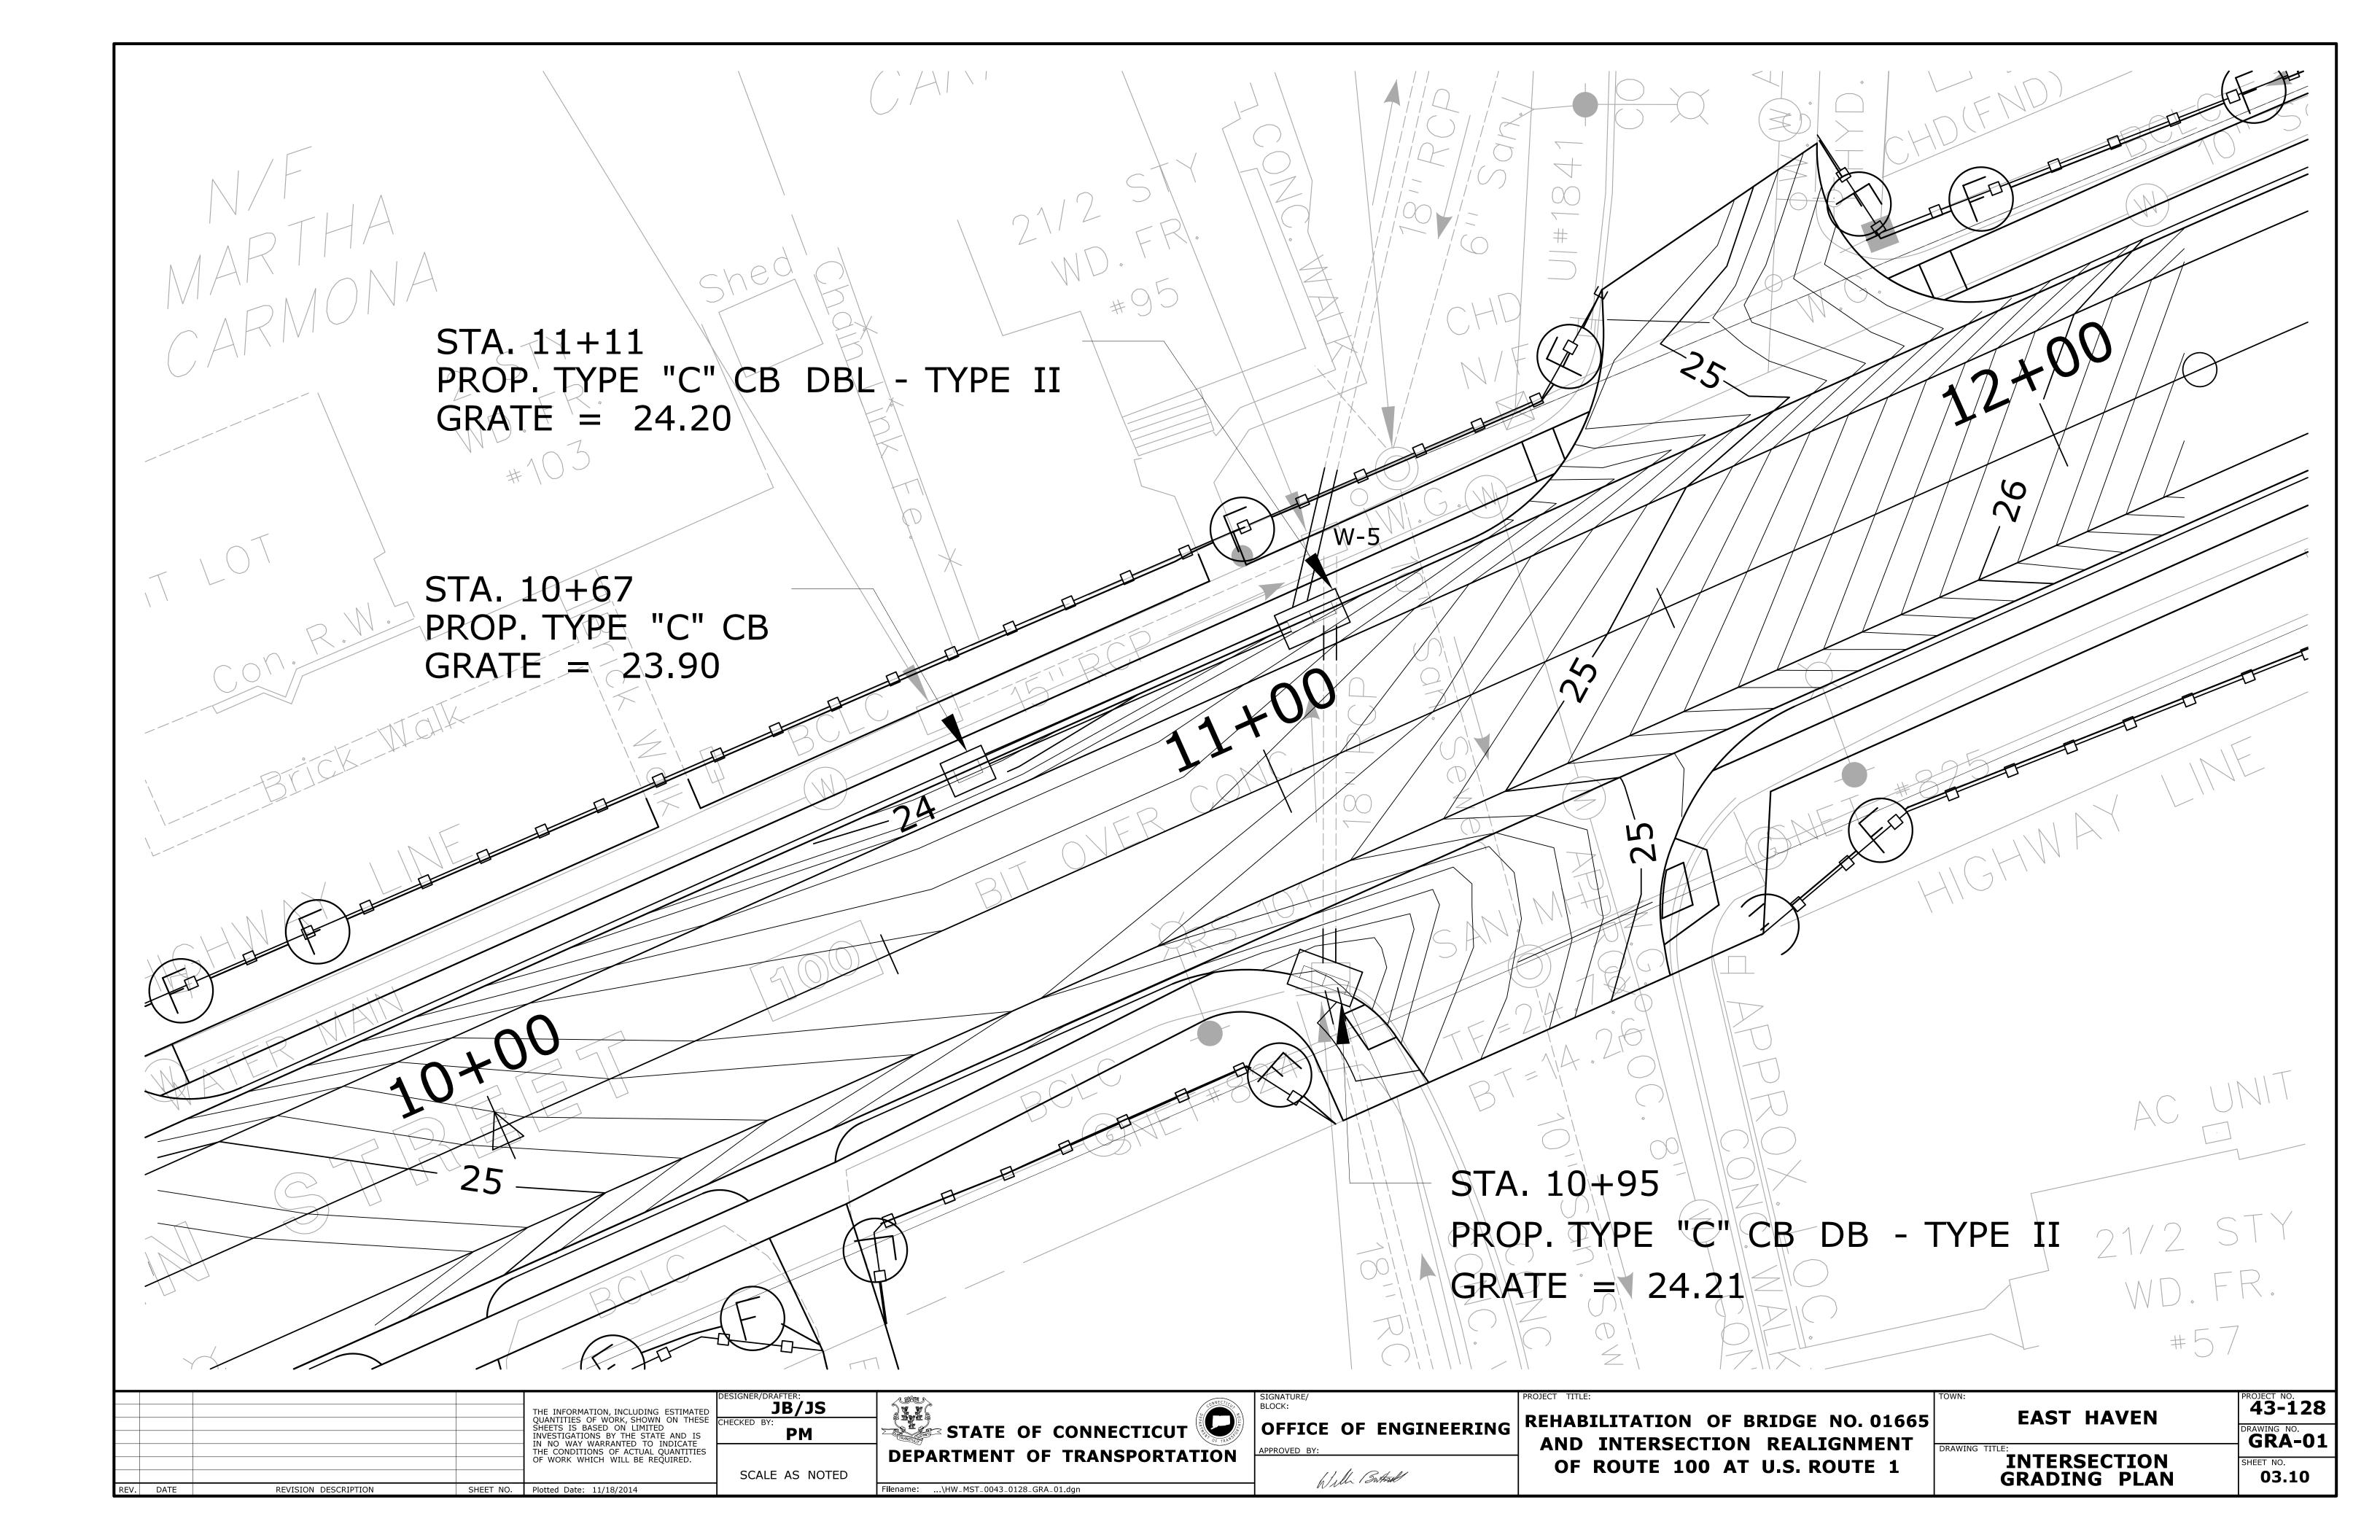


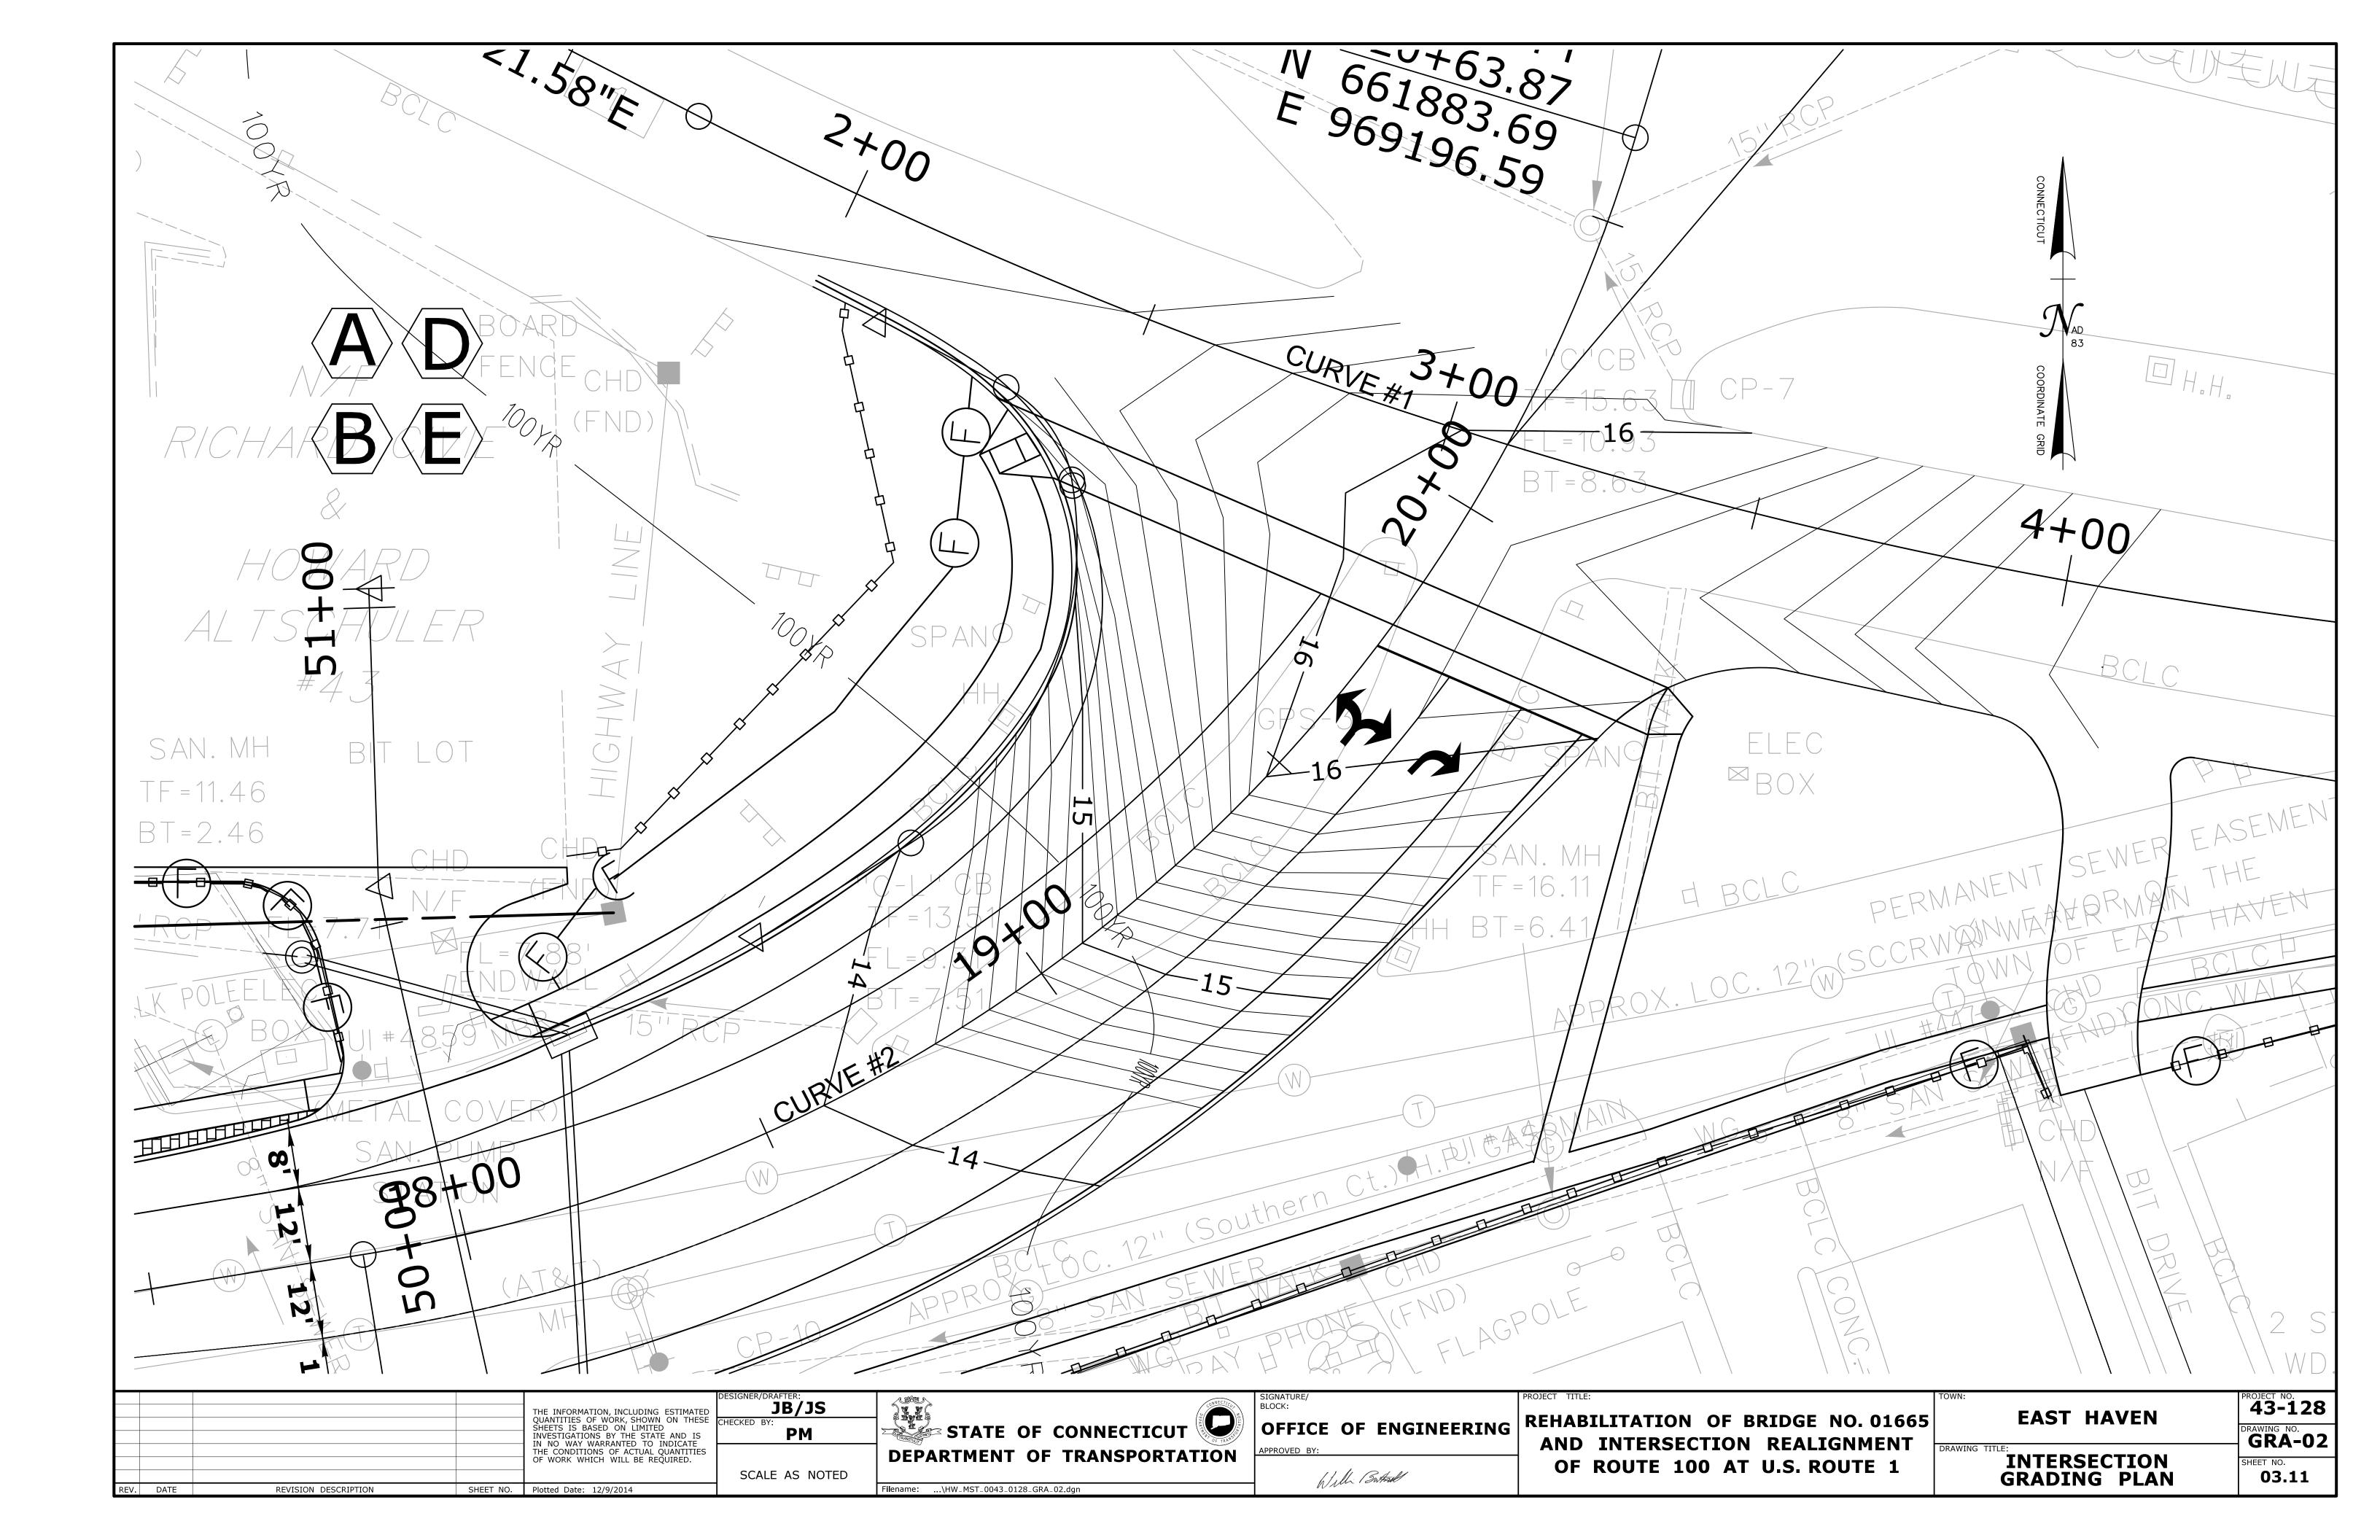


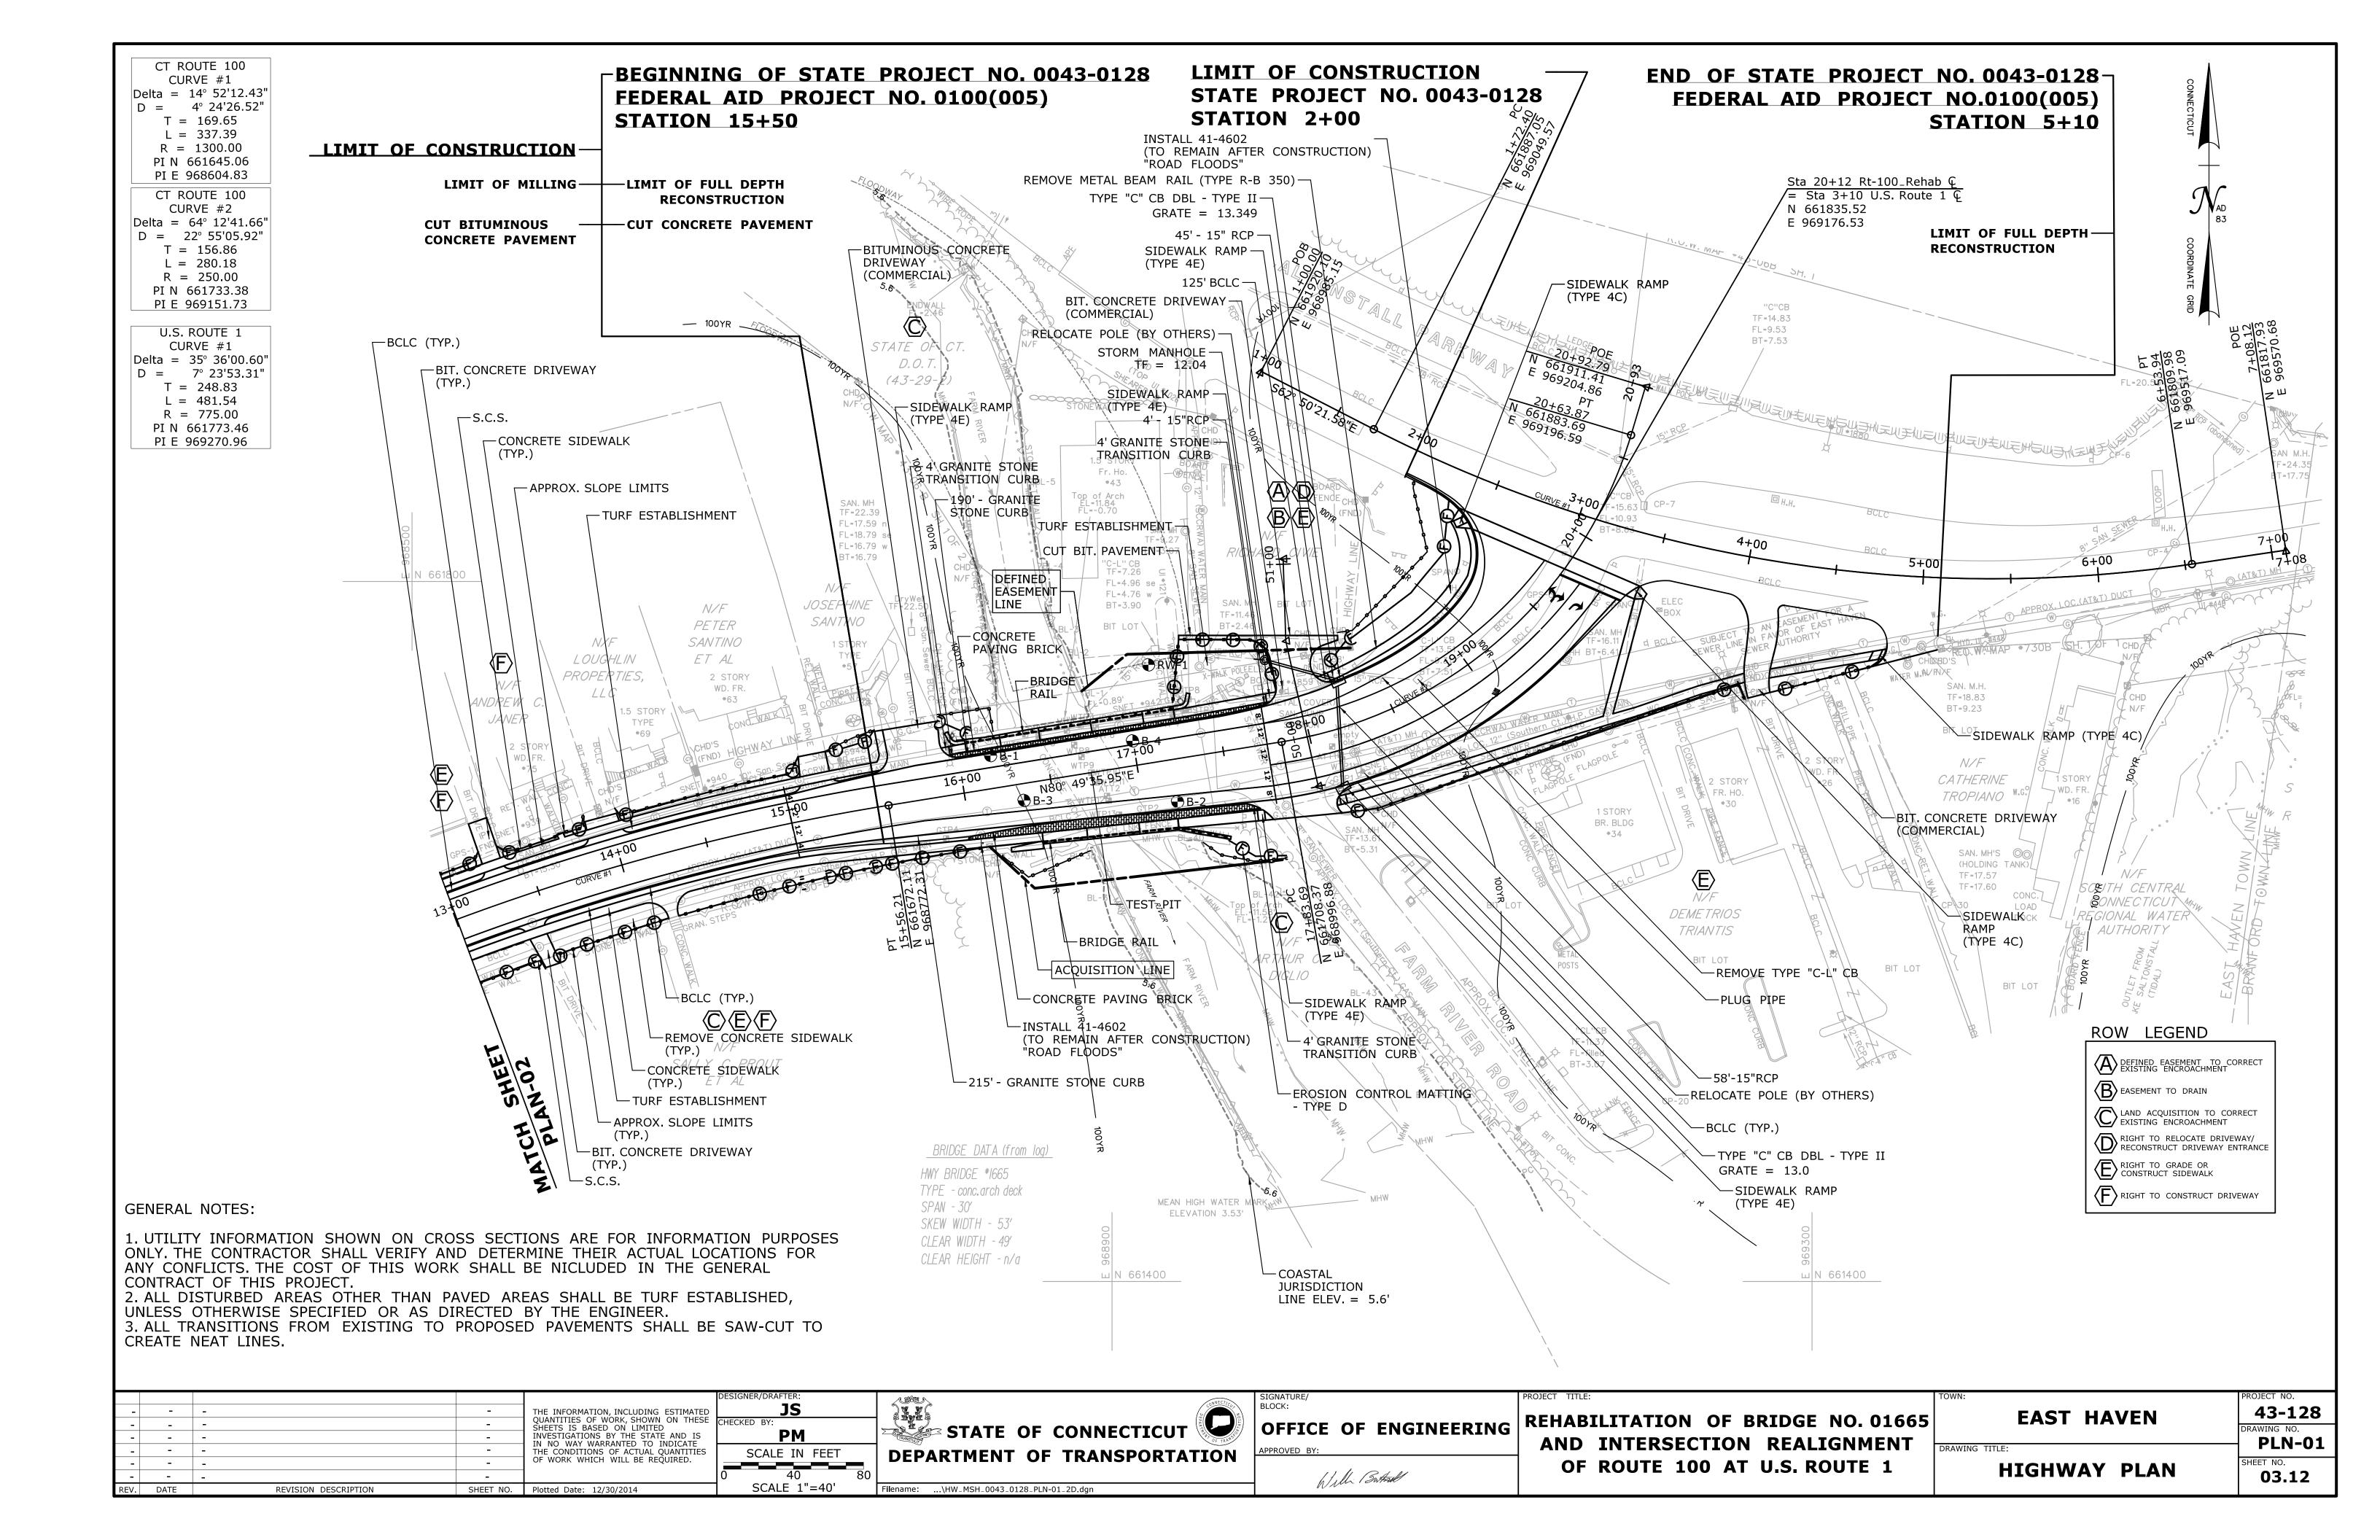

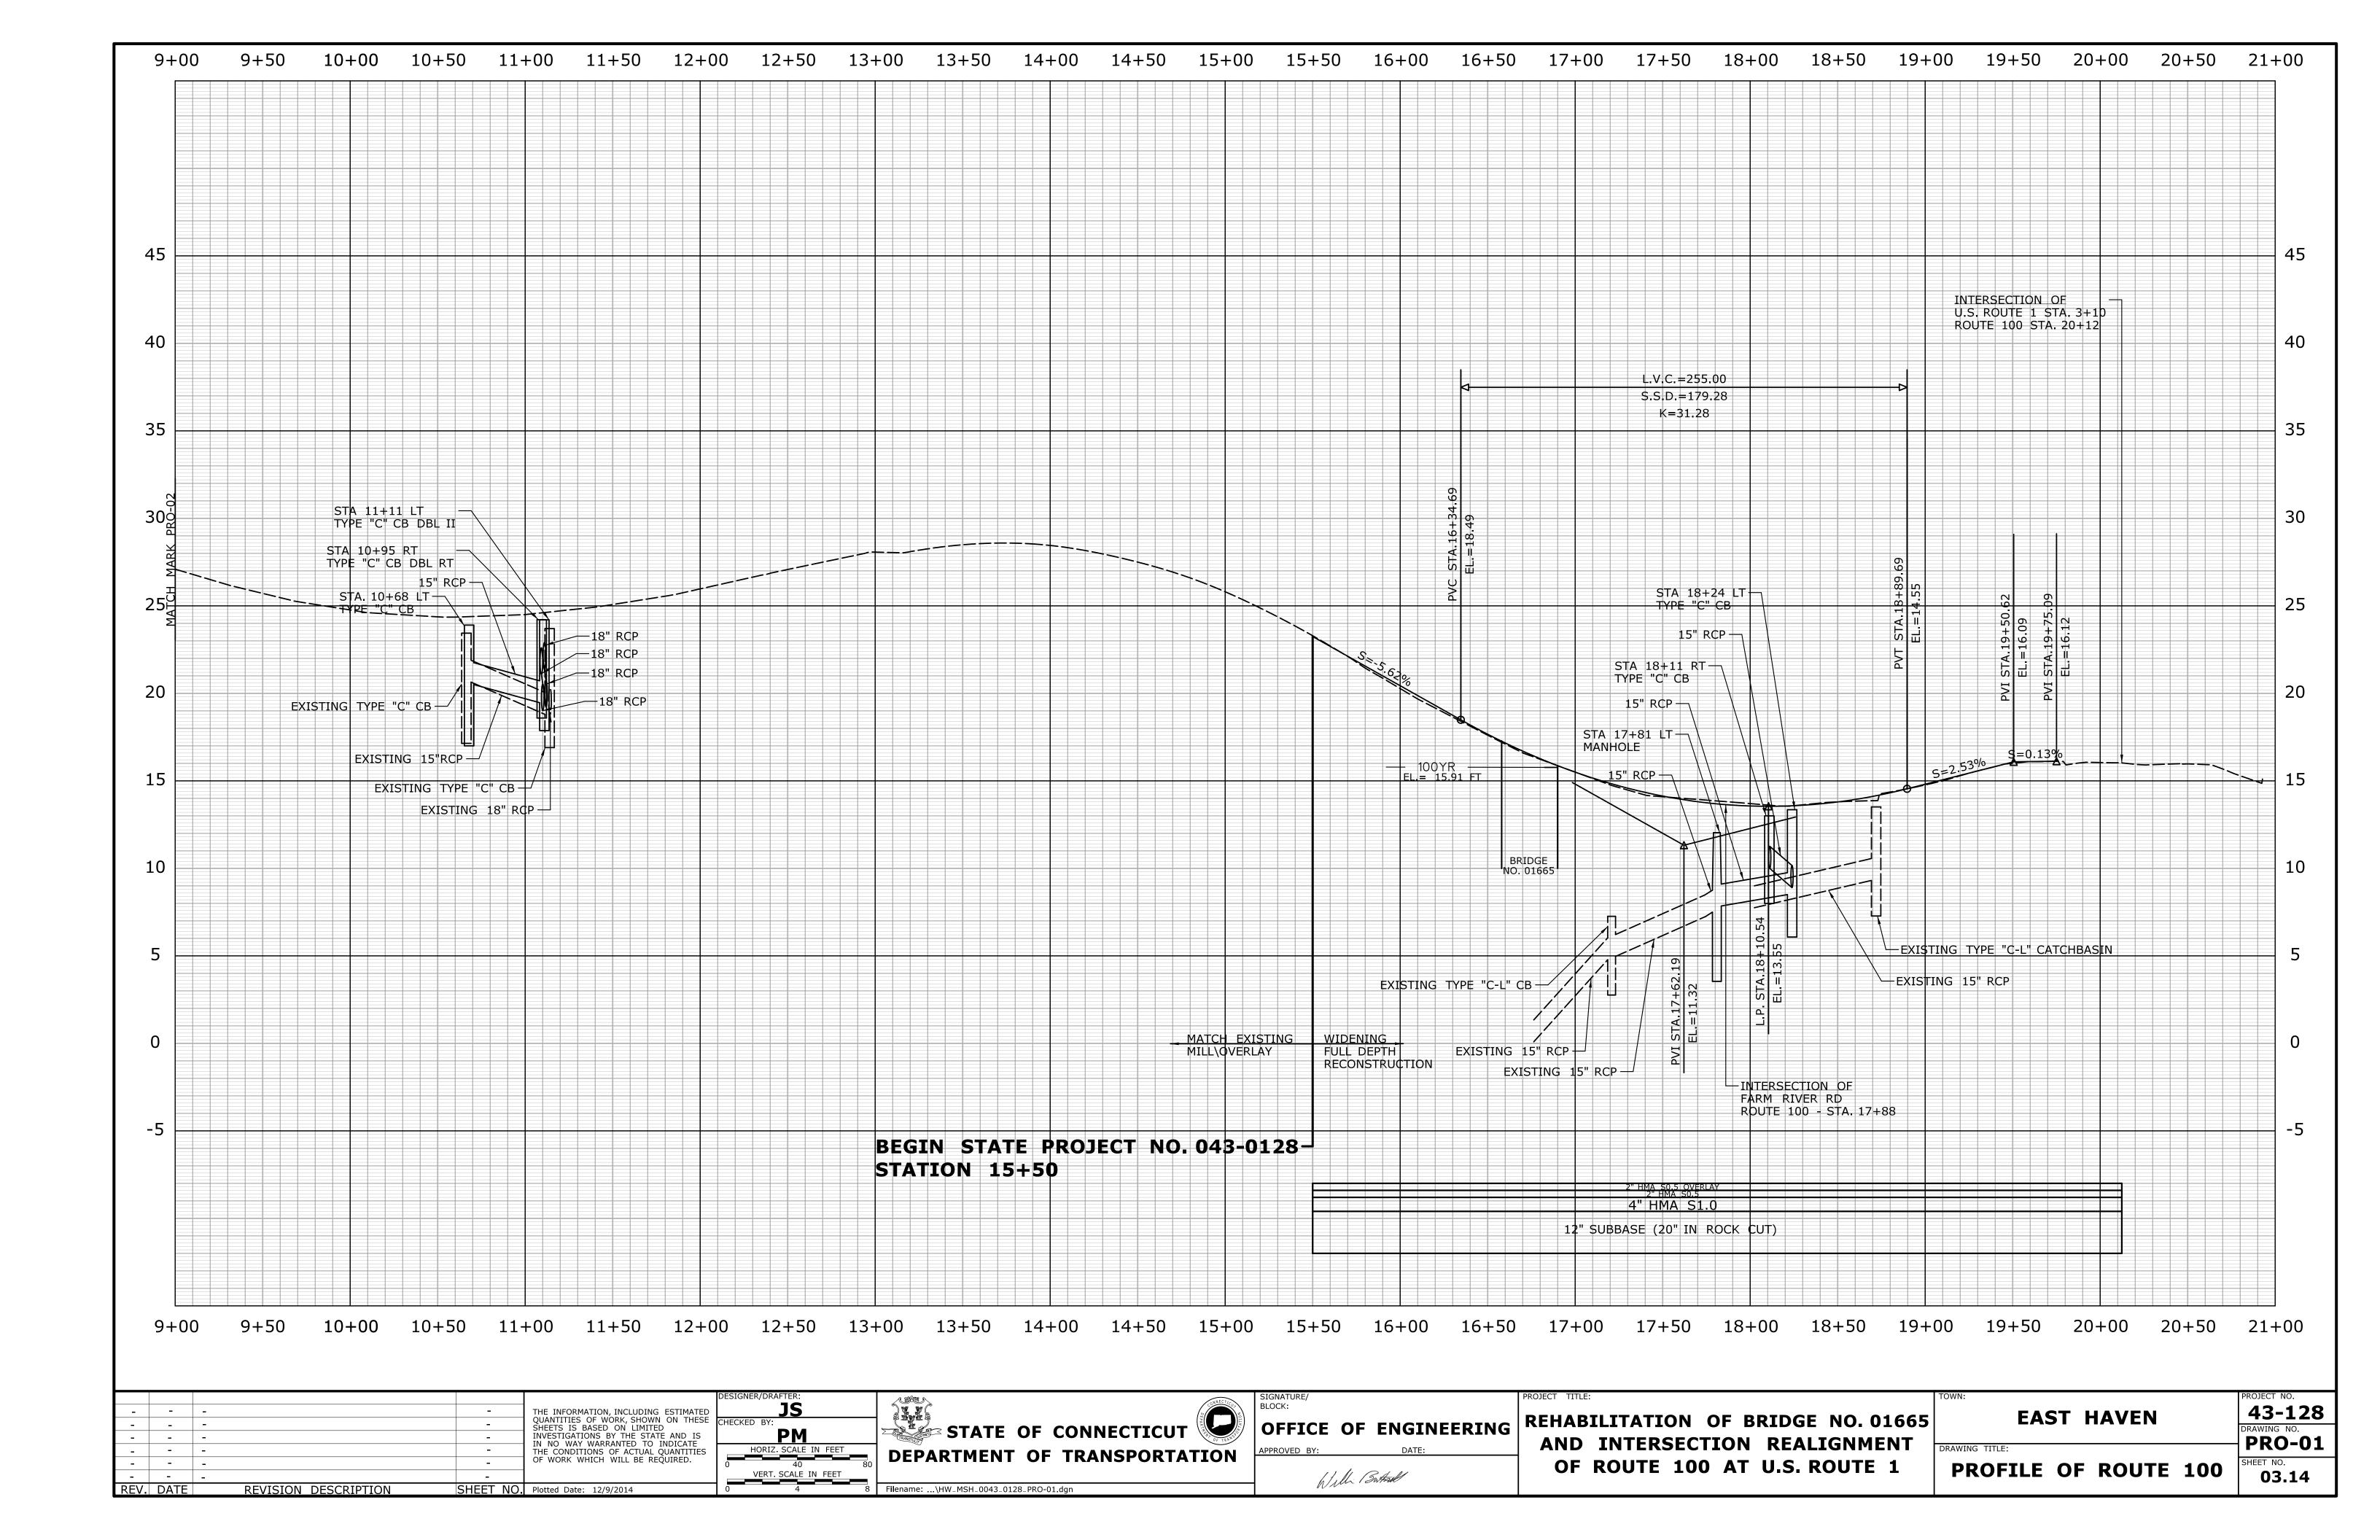

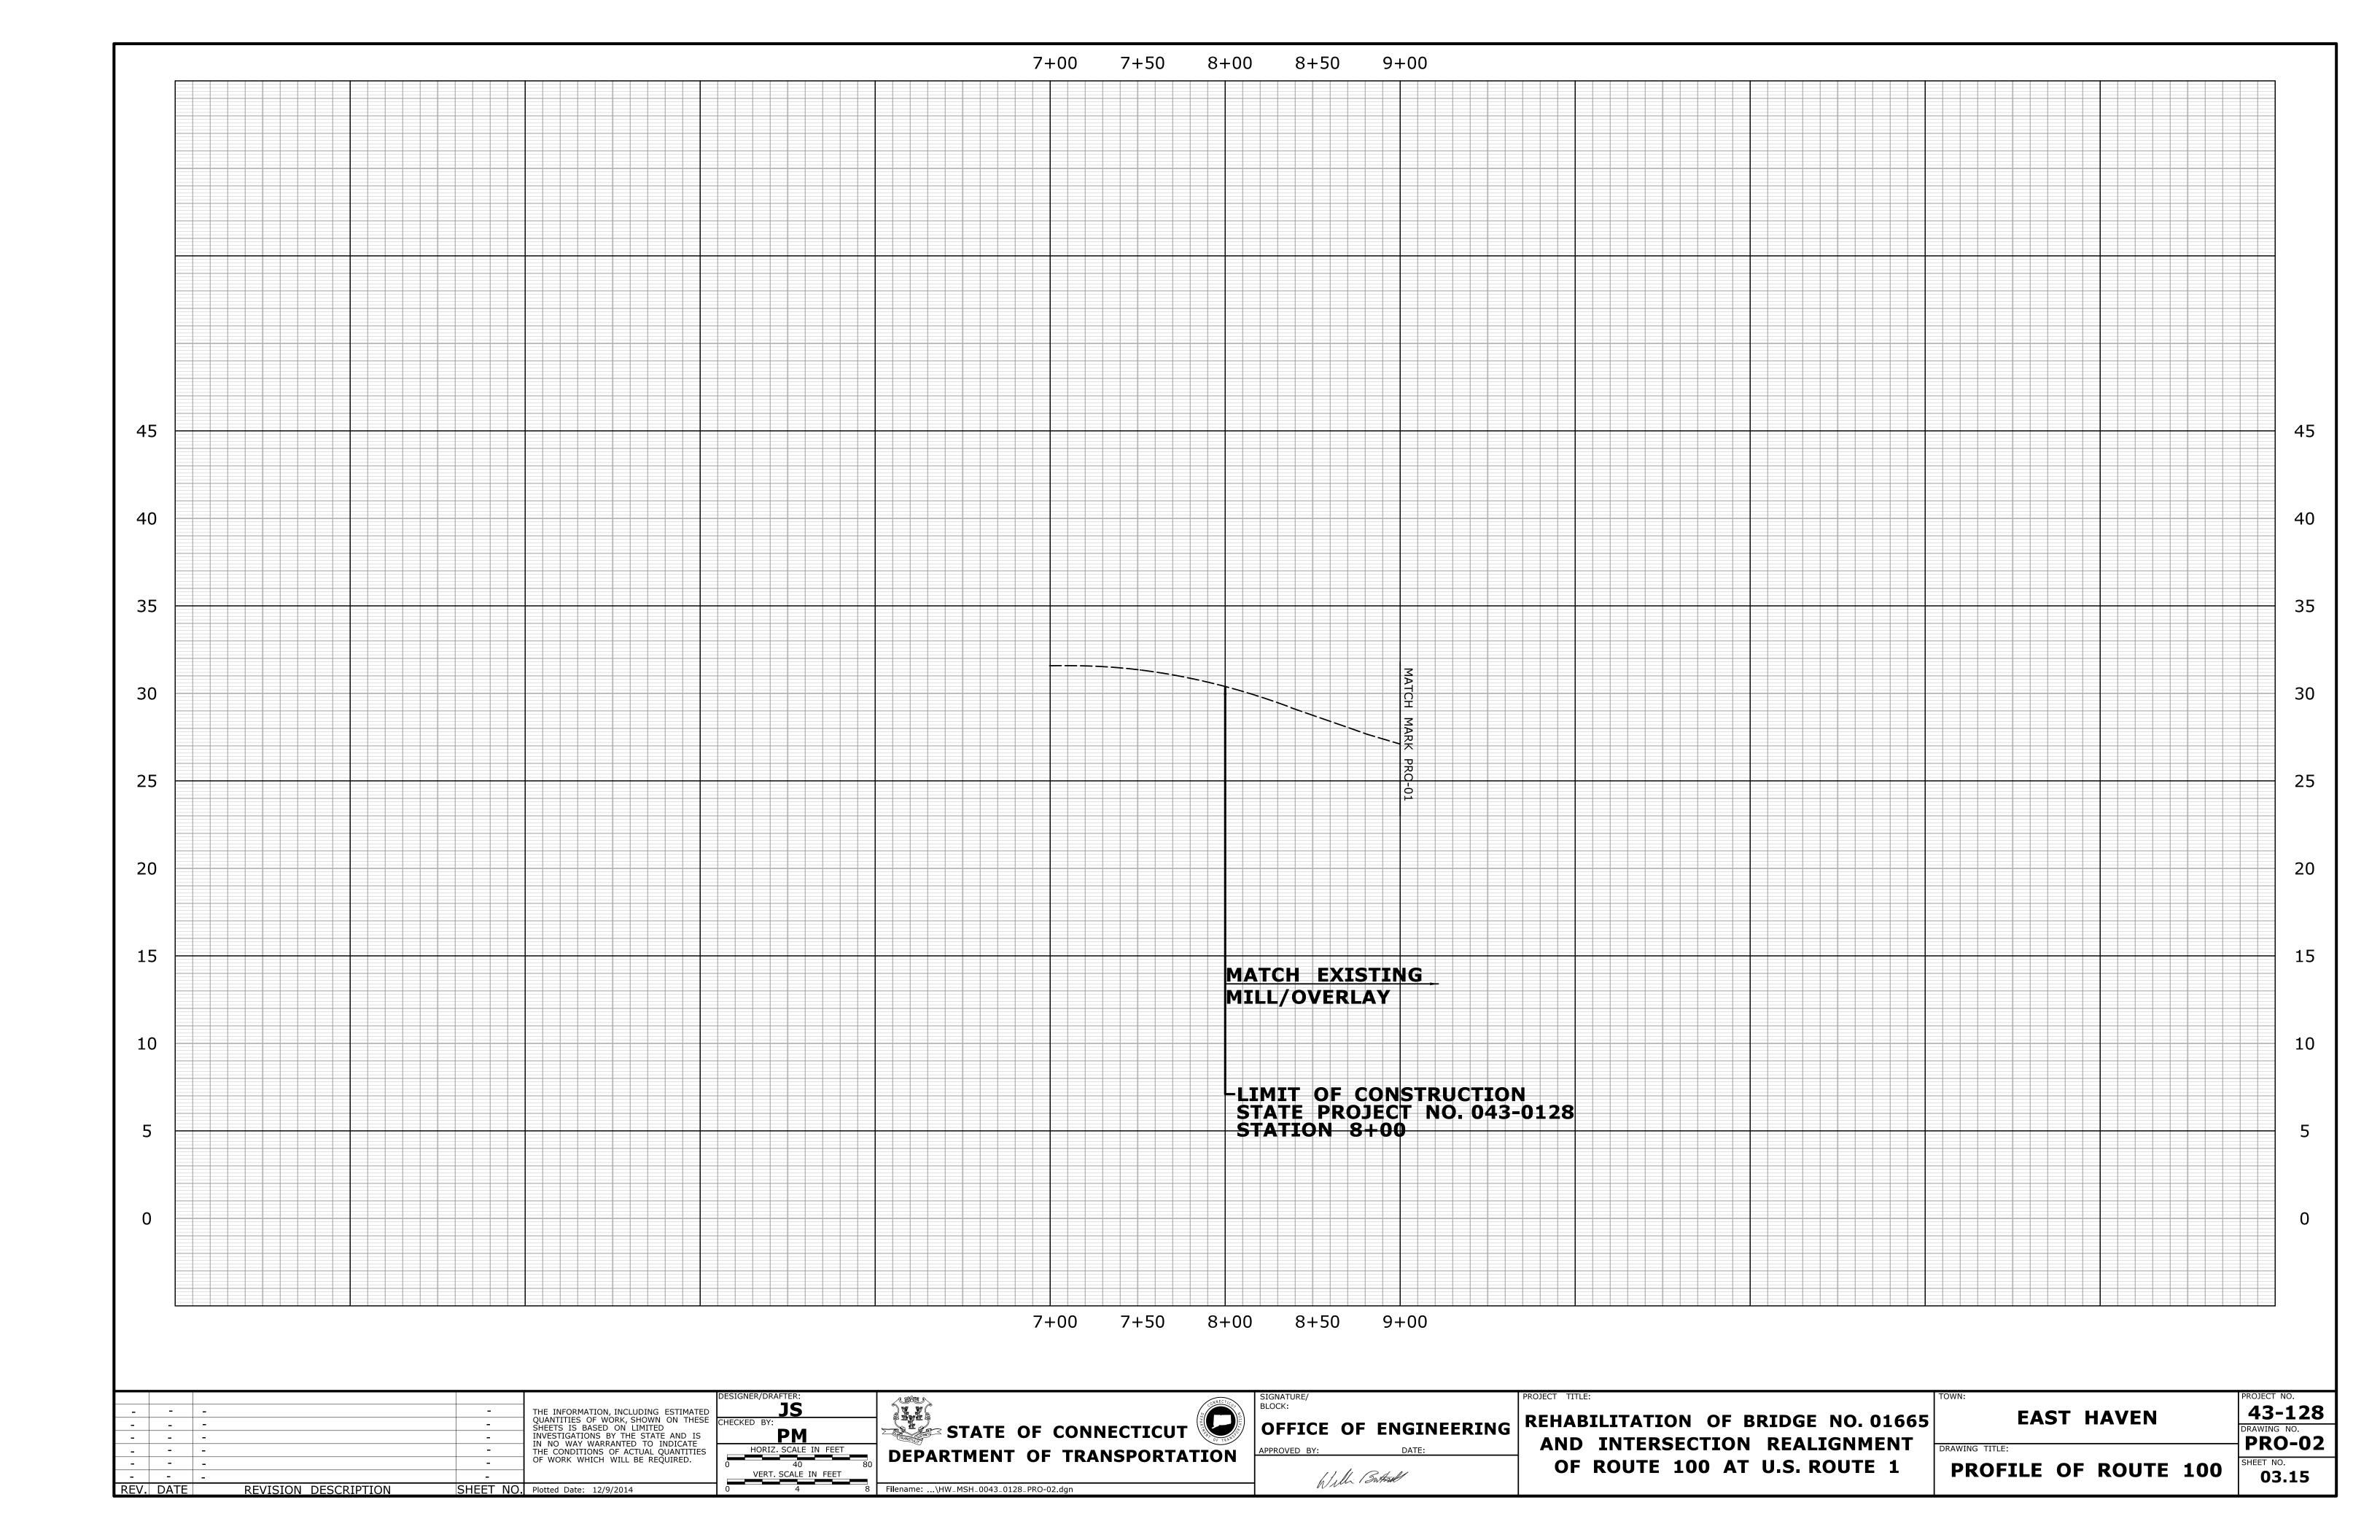

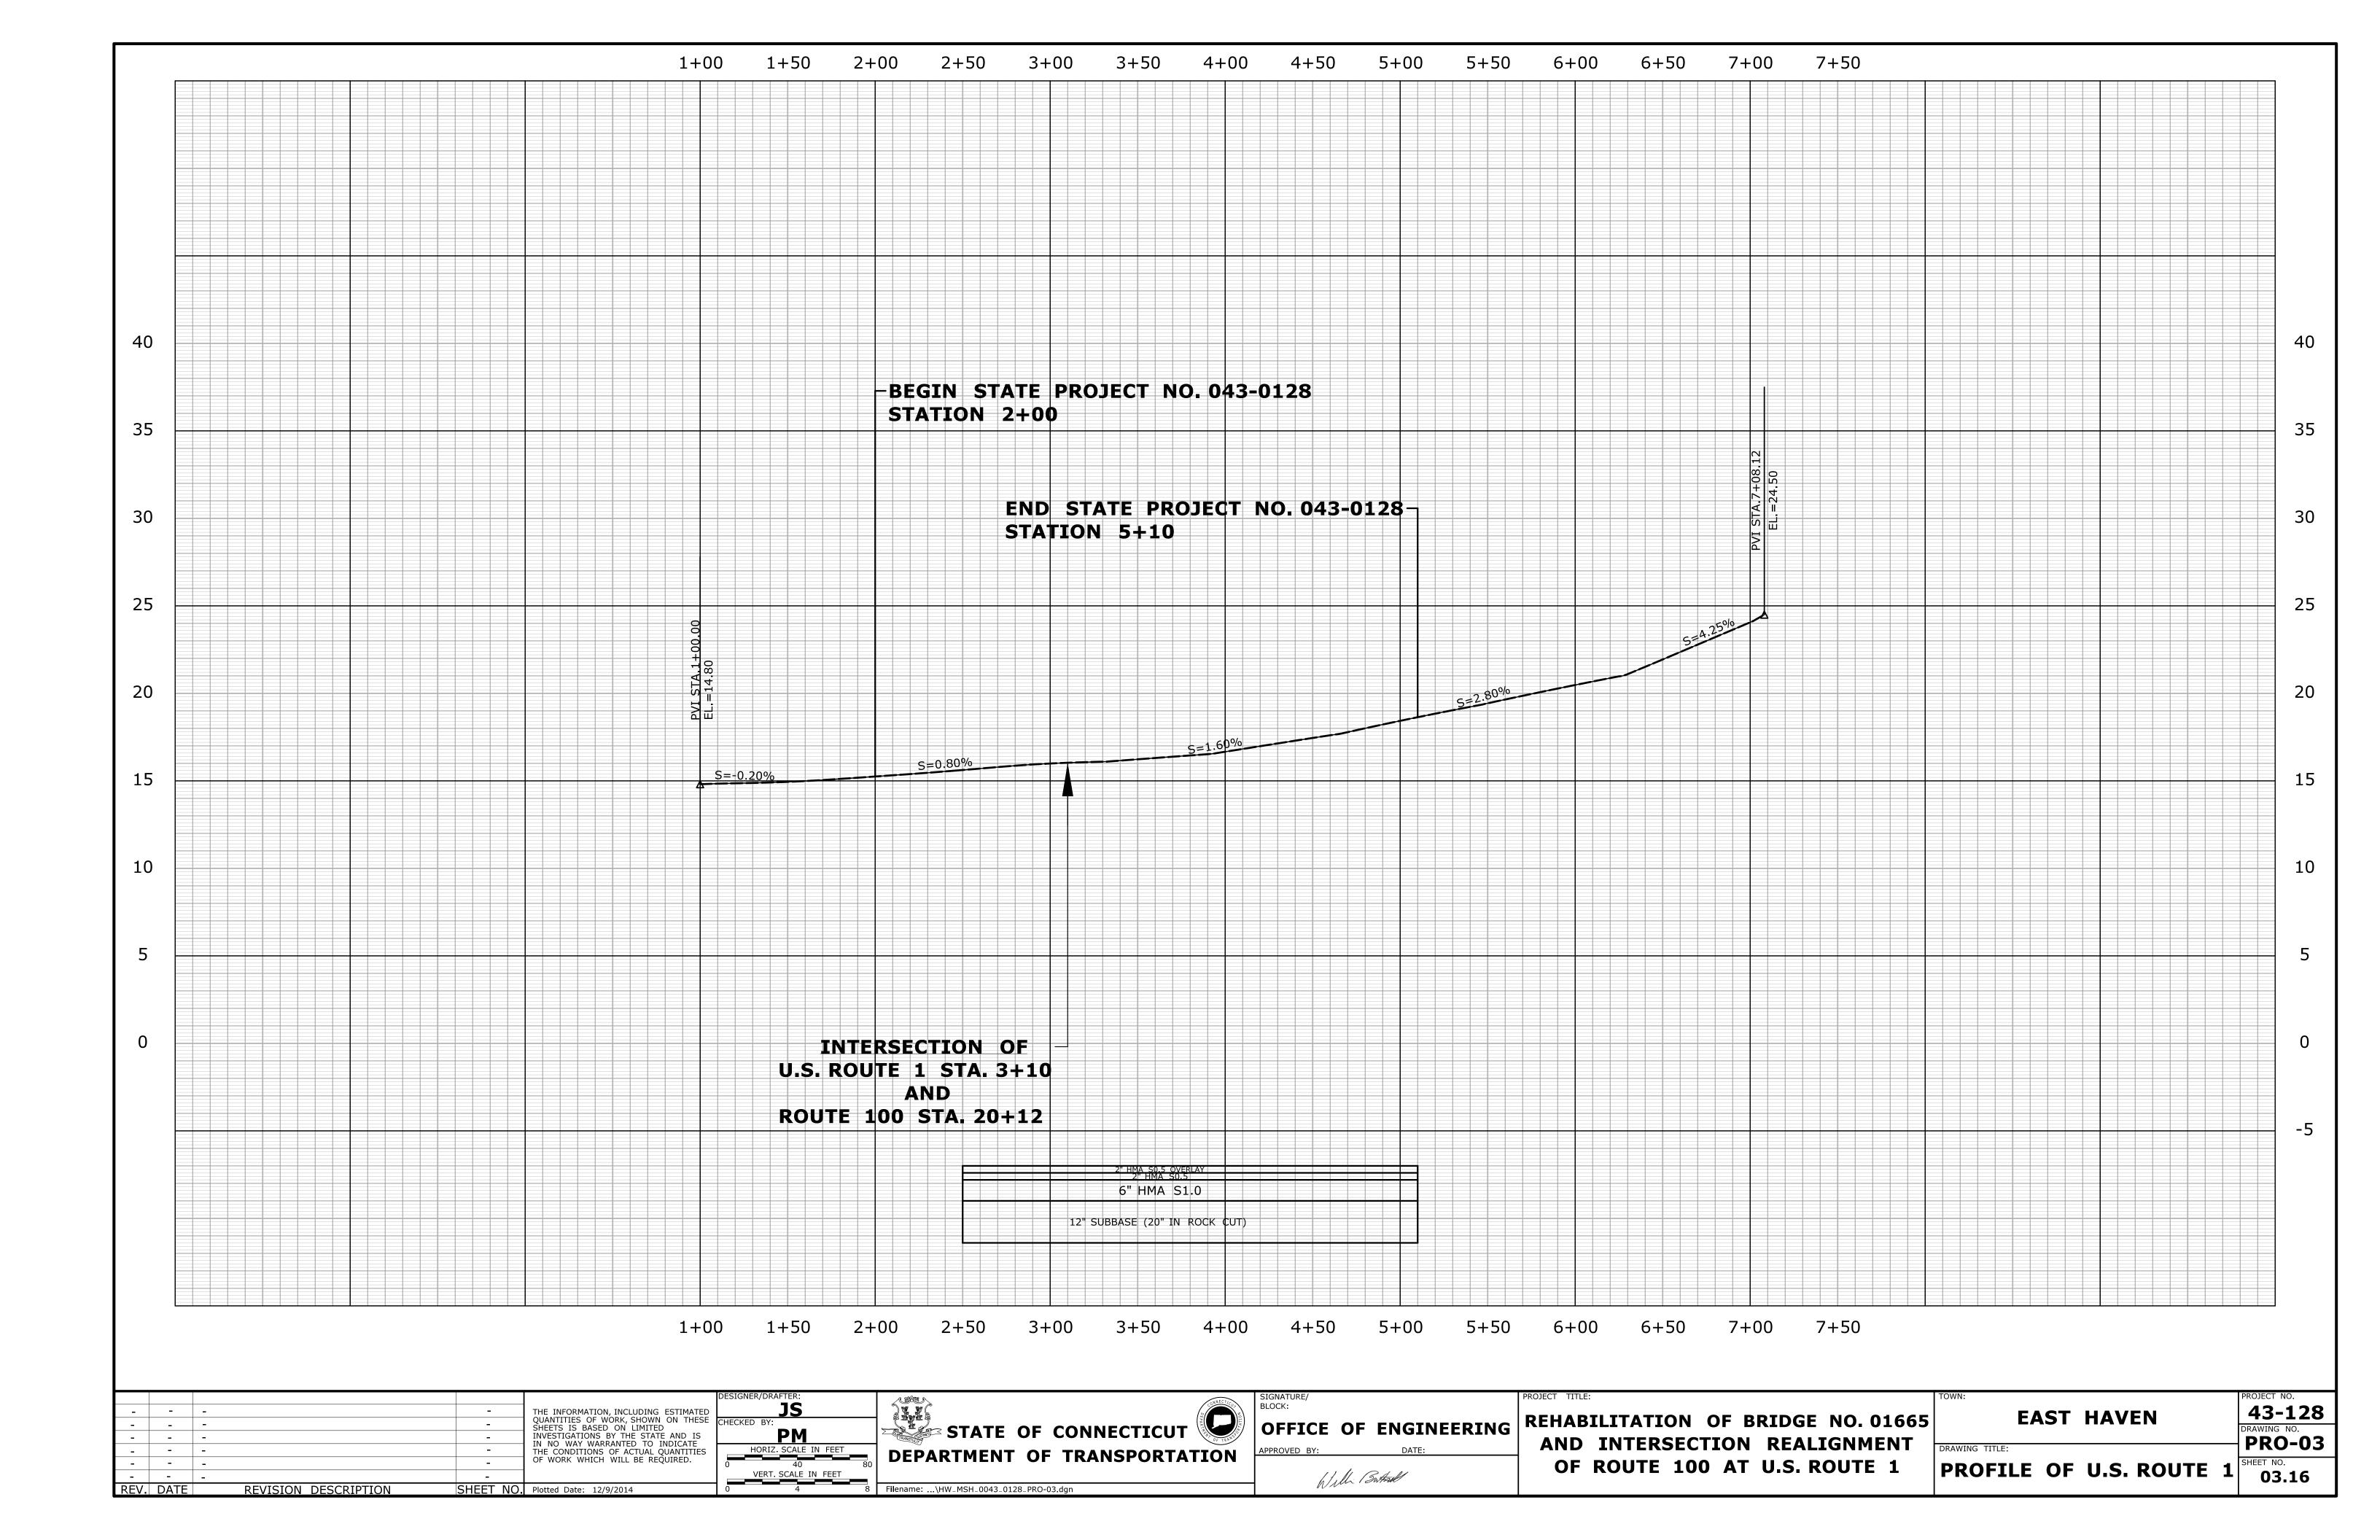

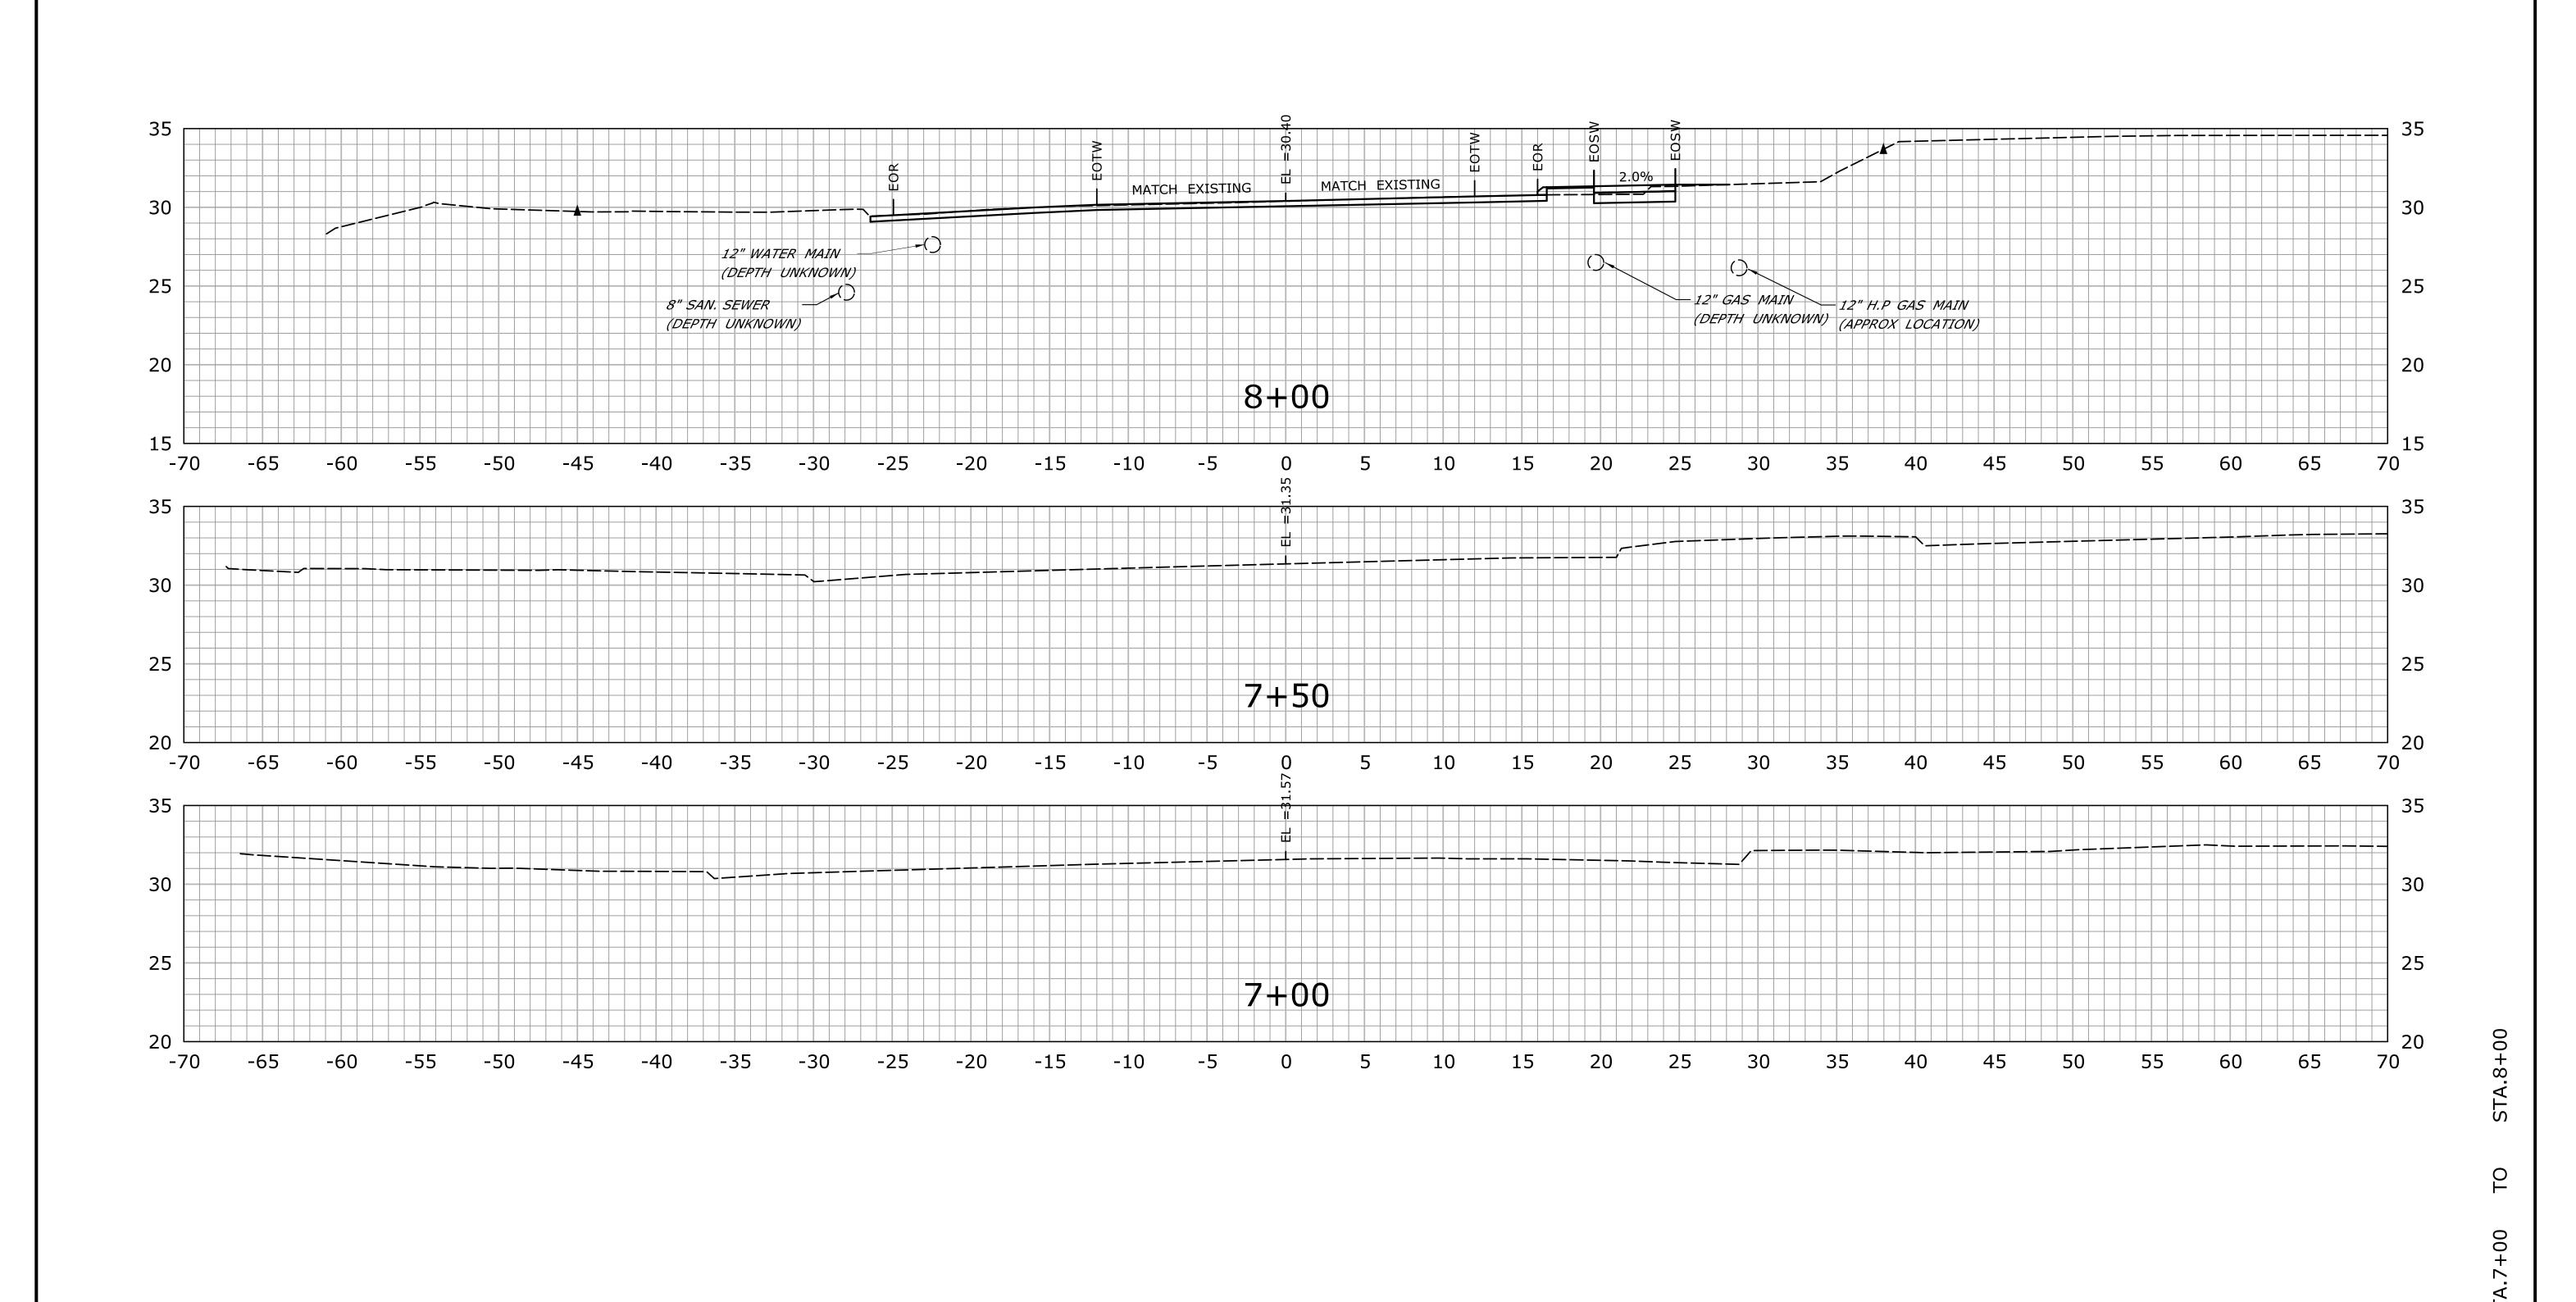

STATE OF CONNECTICUT JS THE INFORMATION, INCLUDING ESTIMATED QUANTITIES OF WORK, SHOWN ON THESE SHEETS IS BASED ON LIMITED INVESTIGATIONS BY THE STATE AND IS IN NO WAY WARRANTED TO INDICATE THE CONDITIONS OF ACTUAL QUANTITIES OF WORK WHICH WILL BE REQUIRED. 43-128 REHABILITATION OF BRIDGE NO. 01665 OFFICE OF ENGINEERING DRAWING NO.
XSC-01 **EAST HAVEN** AND INTERSECTION REALIGNMENT DRAWING TITLE: DEPARTMENT OF TRANSPORTATION SHEET NO. **03.17 CROSS SECTIONS** OF ROUTE 100 AT U.S. ROUTE 1 Will Butterl REV. DATE REVISION DESCRIPTION SHEET NO. Plotted Date: 1/5/2015 Filename: ...\HW_MST_0043_0128_MDL.dgn

